LAND USE PLANS TERRITORIAL ROAD SUBDIVISION T3S, R1E, SECTIONS 28C, TAX LOT 401

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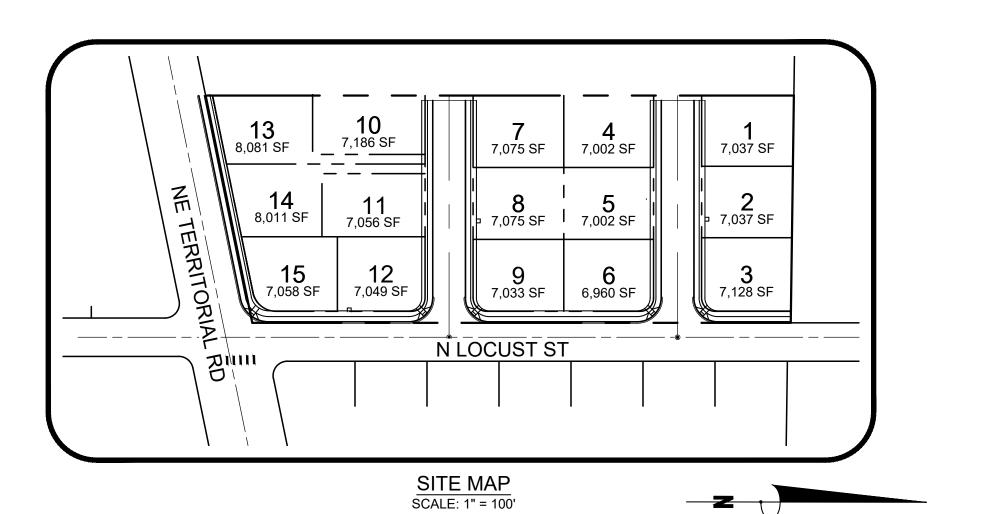
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CENTERLINE MONUMENT
BIOFILTER BAGS FOR INLET PROTECTION
SEWER MANHOLE
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FLOW DIRECTION
WATER VALVE
FIRE HYDRANT
AIR RELEASE VALVE
WATER METER BOX
STREET LIGHTS
UNDERGROUND POWER VAULT
GUY WIRE
POWER POLE
GAS VALVE
TELEPHONE PEDESTAL
TREE
STORM CURB INLET
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CONTOUR MAJOR
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MATCHLINE
BOUNDARY
CENTERLINE
PROPOSED LOT
PUBLIC UTILITY EASEMENT
RIGHT OF WAY
SEWER
WATER
STORM
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EXISTING EASEMENT
EXISTING FENCE
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EXISTING LOT
EXISTING PUBLIC UTILITY EASEMENT
EXISTING RIGHT OF WAY
EXISTING TELEPHONE
EXISTING SEWER
EXISTING WATER
EXISTING STORM DRAIN
EXISTING OVERHEAD UTILITY LINES
SILT FENCE
CHAIN LINK FENCE
EXISTING UNDERGROUND POWER LINE
EXISTING TELECOMMUNICATIONS

ABBREVIATI	ONS
(AB)	AS-BUILT
BND	BEND
BC OR B/C	BACK OF CURB
BOW	BOTTOM OF WALL
BW	BACK OF WALK
C&G	CURB & GUTTER
СВ	CATCH BASIN
CL	CENTERLINE
C/O	CLEANOUT
DTL OR DTLS	DETAIL OR DETAILS
DRN	DRAINAGE
E	ELECTRIC
EA	EACH
EL	ELEVATION
EOP	EDGE OF PAVEMENT
ESMT	EASEMENT
EX	EXISTING
FC	FACE OF CURB
FF	FINISH FLOOR
FH	FIRE HYDRANT
FL	FLOW LINE
FLG	FLANGE
FP	FINISH PAD
G	GUTTER
GB	GRADE BREAK
HP	HIGH POINT
HZ	HORIZONTAL
INV	INVERT ELEVATION
LDR	LOW DENSITY RESIDENTIAL
LP	LOW POINT
L/S	
MDR	MEDIUM DENSITY RESIDENTIAL
MECH	MECHANICAL
MH MJ	MANHOLE MECHANICAL JOINT
P	PAVEMENT
PC	POINT OF CURVATURE
PCC	POINT OF COMPOUND CURVATURE
PL	PROPERTY LINE
PRC	POINT OF REVERSE CURVATURE
PT	POINT OF TANGENCY
REST	RESTRAINT
R/W	RIGHT OF WAY
S=	SLOPE
SC	SCUPPER
SD	STORM DRAIN
STA	STATION
	STANDARD
SVT	SITE VISIBILITY TRIANGLE
SW OR S/W	SIDEWALK
SWR	SEWER
TC	TOP OF CURB
TL	TRUE LENGTH
TEL	TELEPHONE
TOW	TOP OF WALL
VC	VILLAGE CENTER
VERT	
VG W	VALLEY GUTTER WATER
C1 L1	CURVE TABLE NUMBER LINE TABLE NUMBER
R	RIGHT
L	LEFT
LF	
SF	SQUARE FEET
SY	SQUARE YARDS
CY	CUBIC YARDS
W=	WIDTH

CLACKAMAS COUNTY, OREGON





Sheet Number	Sheet Title	
C000	COVER SHEET	
C001	GENERAL NOTES	
C050	1200C COVER SHEET	
C051	DEMO AND PHASE 1 ESCP	
C052	PHASE 2 ESCP	
C100	SITE PLAN AND STREET SECTIONS	
C150	PRELIMINARY PLAT	
C200	OVERALL GRADING AND STORM	
C201	LOCUST ST PLAN & PROFILE	
C202	TERRITORIAL RD PLAN AND PROFILE	
C203	17TH & 18TH AVE PLAN AND PROFILE	
C204	CURB RETURNS PLAN AND PROFILE	
C400	SANITARY AND WATER PLAN & PROFILE	
C600	SIGNING AND STRIPING PLAN	
C700	STREET AND SITE DETAILS	
C701	STREET AND SITE DETAILS	
C702	STORM AND SANITARY DETAILS	
C703	STORM AND SANITARY DETAILS	
C704	WATER DETAILS	
L100	LANDSCAPE PLAN	
E100	LIGHTING PLAN	

PROJECT LOCATION

102 NE TERRITORIAL RD CANBY, OREGON CLACKAMAS COUNTY LATITUDE = 45.277701 LONGITUDE = -122.69210

PROJECT DESCRIPTION

TAX LOT 401 (CLACKAMAS COUNTY TAX MAP) LOCATED IN SECTION 28C, TOWNSHIP 3 SOUTH, RANGE 1 EAST, W.M. CLACKAMAS COUNTY, CITY OF CANBY, OREGON

OWNER/DEVELOPER


VENTURE PROPERTIES, INC. 4230 GALEWOOD ST, STE 100 LAKE OSWEGO, OR 97035 CONTACT: AL JECK PHONE: 503.387.7557 EMAIL: AL@VENTUREPROP.COM

CIVIL ENGINEERING FIRM

ATWELL, LLC. 9755 SW BARNES ROAD, SUITE 150 PORTLAND, OR 97225 CONTACT: BRADY BERRY, PE PHONE: 971.334.8962 EMAIL: BBERRY@ATWELL-GROUP.COM

SURVEYOR

COMPASS LAND SURVEYING 4107 SE INTERNATIONAL WAY, STE 705 MILWAUKIE, OREGON 97222 CONTACT: JOSEPH MCALLISTER, PLS PHONE: 503.496.1489 EMAIL: JOEM@COMPASS-LANDSURVEYORS.COM

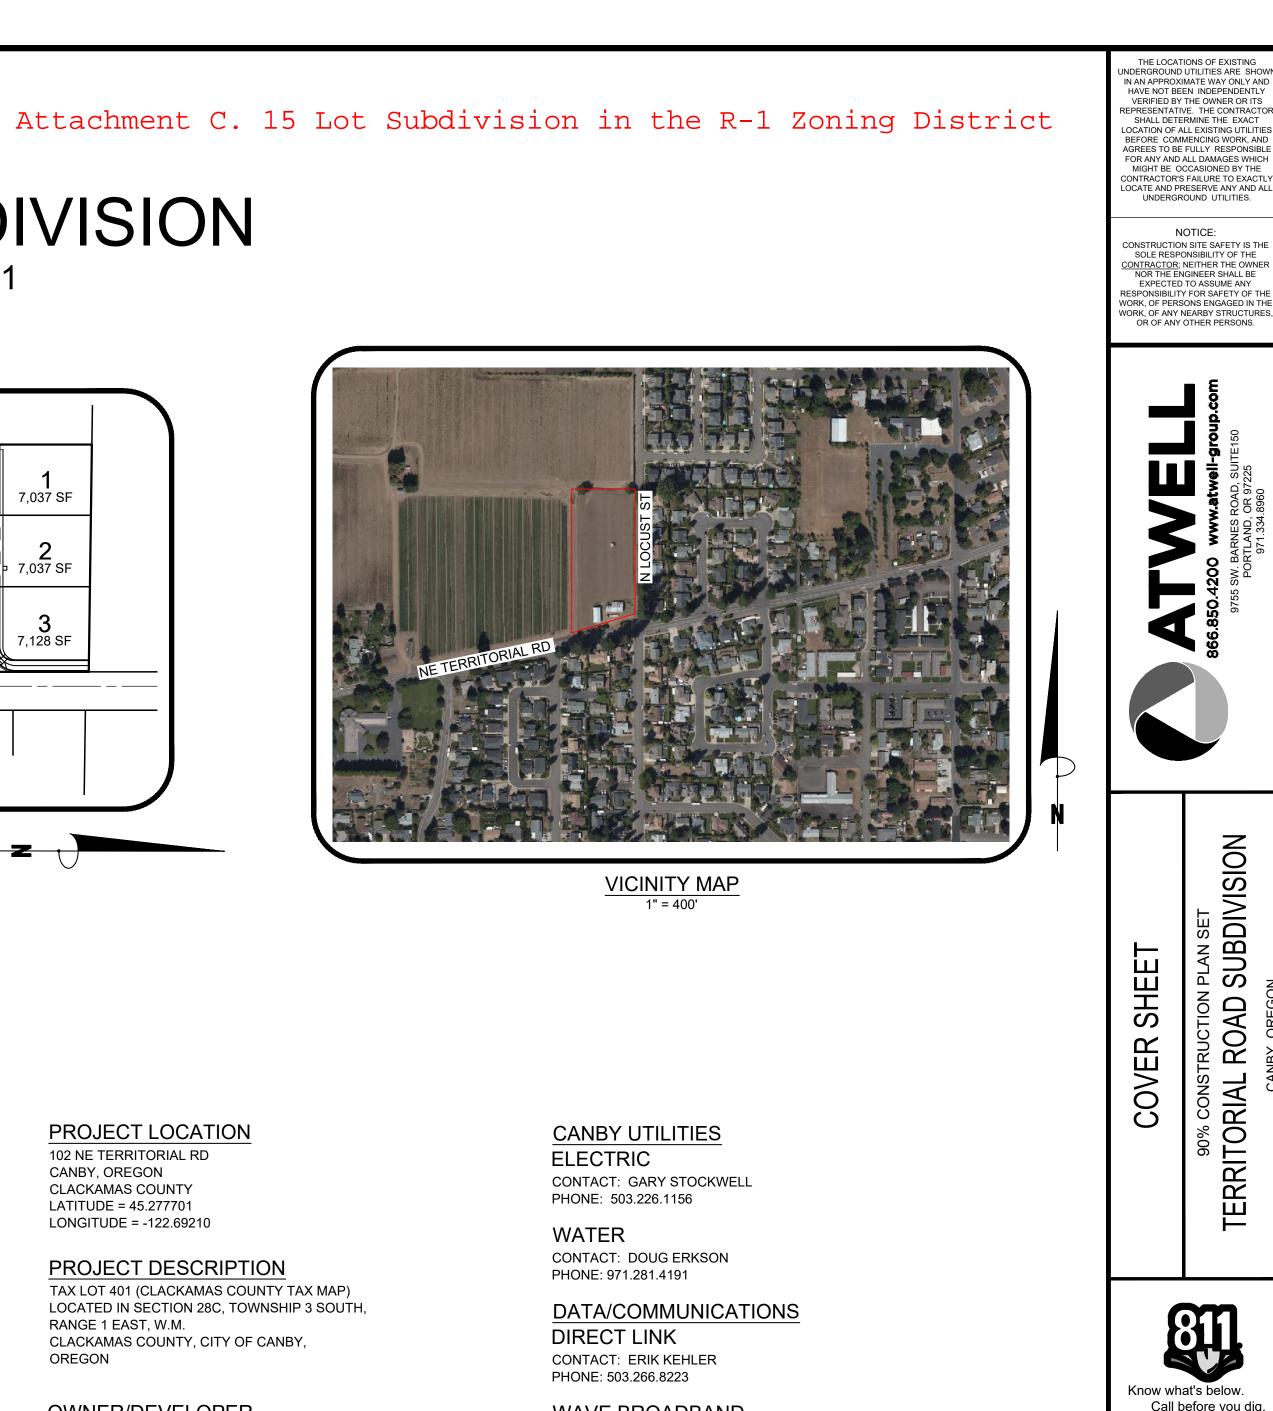

WAVE BROADBAND CONTACT: TRAVIS EDGE PHONE: 503.899.3267

NATURAL GAS

NW NATURAL CONTACT: BRIAN KELLEY PHONE: 503.220.2427

90% CONSTRUCTION PLAN SET RRITORIAL ROAD SUBDIVISION Ξ 81 Know what's below. Call before you dig. **REVISIONS**: EXP.12/31/21 PM. B. BERRY J. ZHANG DR JOB NO. 20002753 FILE NO. 20002753-CS DATE 5/10/2021 SHEET NO. C000

DEMOLITION NOTES

- 1. IN ORDER TO PROTECT ADJACENT PROPERTIES AND WATER RESOURCES FROM SOIL EROSION AND SEDIMENTATION, THE DEMOLITION CONTRACTOR SHALL CONSTRUCT EROSION CONTROL MEASURES PER THE INITIAL EROSION CONTROL PLAN (PHASE I) AS NECESSARY PRIOR TO AND DURING DEMOLITION OPERATIONS. ADDITIONAL MEASURES MAY BY REQUIRED AS DIRECTED BY THE ENGINEER, LOCAL INSPECTOR OR THE OWNER.
- 2. ANY DISCREPANCIES BETWEEN THESE PLANS AND ACTUAL FIELD CONDITIONS SHALL BE BROUGHT TO THE ATTENTION OF THE OWNER'S REPRESENTATIVE OR THE ENGINEER PRIOR TO THE COMMENCEMENT OF ANY DEMOLITION. ANY DEVIATION WITHOUT THE OWNERS' CONSENT WILL BE AT THE CONTRACTOR'S RISK.
- 3. THE DEMOLITION CONTRACTOR SHALL LOCATE, IDENTIFY PROPERLY, TERMINATE, AND MARK ALL EXISTING UTILITIES THAT SHALL REMAIN WITHIN THE DEMOLITION AREA TO PROTECT THEM FROM DAMAGE.
- 4. THE DEMOLITION CONTRACTOR SHALL NOTIFY ALL UTILITY COMPANIES, ASSOCIATED GOVERNMENT DEPARTMENTS, AND THE OWNER'S REPRESENTATIVE PRIOR TO INTERRUPTION OF ANY UTILITY SERVICE. NOTIFICATION MUST BE MADE PER THE PROJECT SPECIFICATIONS. THE DEMOLITION CONTRACTOR SHALL BE RESPONSIBLE FOR COORDINATION WITH AND ADHERENCE T0 THE REQUIREMENTS OF EACH UTILITY COMPANY AND ANY GOVERNMENT UTILITY DEPARTMENT REGARDING SERVICE INTERRUPTION
- 5. THE DEMOLITION CONTRACTOR SHALL PROTECT ALL LANDSCAPING AND OTHER FEATURES DESIGNATED TO REMAIN AND REPLACE/REPAIR ALL ITEMS THAT ARE DISTURBED DURING DEMOLITION.
- 6. THE CONTRACTOR SHALL CONDUCT ALL DEMOLITION OPERATIONS WITH MINIMUM INTERFERENCE TO PUBLIC AND/OR PRIVATE ACCESSES AND FACULTIES.
- 7. THE DEMOLITION CONTRACTOR SHALL PROTECT BENCH MARKS, PROPERTY CORNERS, AND ALL OTHER SURVEY MONUMENTS FROM DAMAGE OR DISPLACEMENT. IF A MARKER IS REMOVED OR DISTURBED, IT SHALL BE REPLACED BY A LICENSED LAND SURVEYOR AT THE CONTRACTORS EXPENSE.
- 8. THE DEMOLITION CONTRACTOR SHALL PROVIDE TRAFFIC CONTROL MEASURES AS REQUIRED IN ACCORDANCE WITH THE US DEPT. OF TRANSPORTATION MANUAL OF UNIFORM TRAFFIC CONTROL DEVICES AND GOVERNING AGENCY REQUIREMENTS
- 9. DEPRESSIONS AND VOID AREAS CAUSED BY DEMOLITION WORK SHALL BE FILLED TO SUB-GRADE AND PROPERLY COMPACTED. THE CONTRACTOR SHALL SLOPE ALL DISTURBED AREAS TO DRAIN IN ORDER TO AVOID PONDING
- 10. THE DEMOLITION CONTRACTOR SHALL ACQUIRE ALL PERMITS AND PAY ALL ASSOCIATED FEES PERTAINING TO THE DEMOLITION AND DISPOSAL REQUIREMENTS. HE SHALL BE RESPONSIBLE FOR ADHERENCE TO ALL LOCAL, STATE, AND FEDERAL REQUIREMENTS REGARDING THIS WORK. IF THERE ARE NO LOCAL, STATE OR FEDERAL REQUIREMENTS THE DEMOLITION CONTRACTOR SHALL ACQUIRE AN ENGINEER'S CERTIFICATION THAT THE WORK HAS BEEN PERFORMED IN ACCORDANCE WITH THE APPROVED PLANS.
- 11. THE CONTRACTOR IS RESPONSIBLE FOR JOB SITE SAFETY AND SAFETY MANAGEMENT. THE CONTRACTOR SHALL PROCEED WITH THE DEMOLITION IN AN ORGANIZED MANNER FOLLOWING ALL APPLICABLE OSHA REQUIREMENTS IN ORDER TO ENSURE WORKER AND CIVIC SAFETY.
- 12. THE DEMOLITION CONTRACTOR SHALL DO THE FOLLOWING:
- 12.1. CONFIRM THAT COPIES OF ALL PERMITS AND APPROVALS ARE KEPT ONSITE AND THAT THEY ARE AVAILABLE FOR REVIEW UPON REQUEST.
- 12.2. INSTALL INITIAL PHASE SOIL EROSION AND SEDIMENT CONTROL MEASURES PRIOR TO SITE DISTURBANCE.
- 12.3. REMOVE AND DISPOSE OFFSITE ALL DEBRIS NOT ACCEPTABLE TO THE OWNER. LOCATE AND CAP/PLUG ALL WET AND DRY UTILITIES TO BE REMOVED/ABANDONED 124 WITHIN THE LIMITS OF DISTURBANCE.
- 12.5. PROTECT AND KEEP IN OPERATION ALL ACTIVE SYSTEMS THAT ARE NOT TO BE REMOVED/ABANDONED.
- COORDINATE WITH APPROPRIATE UTILITY SERVICE COMPANY/PROVIDER AND PROVIDE THE OWNER WITH WRITTEN NOTIFICATION THAT THE EXISTING UTILITIES AND SERVICES HAVE BEEN TERMINATED AND ABANDONED IN ACCORDANCE WITH JURISDICTIONAL AND/OR UTILITY COMPANY REQUIREMENTS. COORDINATION WITH UTILITY COMPANIES REGARDING WORKING DURING "OFF-PEAK" HOURS OR ON WEEKENDS TO MINIMIZE THE IMPACT ON THE PUBLIC.
- DIRECT A LICENSED ENVIRONMENTAL TESTING COMPANY COMPLETE A CONTAMINANT 12.7. AND INSPECTION AND REPORT WITH REGARD TO BUILDINGS/STRUCTURES TO BE REMOVED. AND ACCORDANCE WITH APPLICABLE LOCAL. STATE AND FEDERAL ENVIRONMENTAL REGULATIONS. CONTAMINATED/HAZARDOUS BUILDING MATERIAL AND/OR SOILS SHALL BE REMOVED AND DISPOSED OF OFFSITE BY A QUALIFIED/LICENSED CONTRACTOR FAMILIAR WITH THE APPLICABLE REGULATIONS.
- 13. EXPLOSIVES SHALL NOT BE USED WITHOUT PRIOR WRITTEN CONSENT OF BOTH THE OWNER AND APPLICABLE GOVERNMENTAL AUTHORITIES. IF PERMISSION IS GIVEN, ALL RELATED PERMITS AND MEASURES SHALL BE AT THE DIRECTION OF THE LOCAL ISSUING AUTHORITY. THE CONTRACTOR SHALL BE RESPONSIBLE FOR ALL INSPECTIONS AND SEISMIC VIBRATION TESTING REQUIRED FOR PROPER MONITORING OF LOCAL STRUCTURES IN THE AREA.
- 14. THE CONTRACTOR SHALL PROVIDE TRAFFIC CONTROL AND GENERALLY ACCEPTED SAFE PRACTICES IN ACCORDANCE WITH "THE MANUAL ON UNIFORM TRAFFIC CONTROL", AS WELL AS FEDERAL, STATE, AND LOCAL REGULATIONS SHOULD DEMOLITION RELATED ACTIVITIES IMPACT ROADWAYS OR RIGHTS-OF-WAY. STREET CLOSURES MUST BE APPROVED BY THE APPROPRIATE GOVERNMENTAL AUTHORITY.
- 15. EQUIPMENT AND OPERATION OF EQUIPMENT SHALL BE CONTROLLED TO WITHIN THE LIMITS OF DISTURBED ONSITE AREA OF THE PROPERTY.

SITE NOTES

- 1. THE PROJECT BOUNDARY SURVEY HAS BEEN PROVIDED BY COMPASS LAND SURVEYING. (THE ENGINEER SHALL NOT BE HELD RESPONSIBLE FOR THE ACCURACY OF THE SURVEY, OR FOR DESIGN ERRORS OR OMISSIONS AS A RESULT OF SURVEY INACCURACIES.)
- 2. THE BUILDING CONTRACTOR SHALL BE RESPONSIBLE FOR INSTALLING ALL BUILDINGS AND BUILDING APPURTENANCES WITHIN FIVE (5) FEET OF THE BUILDING WALL TO INCLUDE TRUCK DOCKS, SIDEWALKS, STEPS, ETC.
- 3. THE SITE CONTRACTOR SHALL BE RESPONSIBLE FOR INSTALLING ALL SITE WORK AND SITE APPURTENANCES UP TO FIVE (5) FEET OF THE BUILDING. THIS INCLUDES TRANSFORMER AND DUMPSTER PADS AS WELL AS ALL UTILITY CONDUITS.
- 4. CONTRACTOR SHALL OBTAIN ALL PERMITS FROM THE OWNER PRIOR TO CONSTRUCTION. 5. ALL DIMENSIONS AND RADII ARE TO THE FACE OF CURB AND TO THE END OF PARKING STRIPE UNLESS OTHERWISE NOTED. ALL DIMENSIONS SHOWN TO BUILDINGS ARE TO THE OUTSIDE FACE OF THE BUILDING.
- 6. ALL STRIPED OR CURBED RADII SHALL BE 3' UNLESS OTHERWISE NOTED.
- PARKING LOT STRIPING SHALL HAVE TWO (2) COATS OF PAINT (MIN).

- 8. ALL HANDICAP ACCESSIBLE PARKING SIGNS AND STRIPING SHALL BE INSTALLED IN ACCORDANCE WITH THE AMERICAN WITH DISABILITY ACT (ADA) REQUIREMENTS. LOCAL CODES MAY GIVE ADDITIONAL DIRECTION WITH REGARD TO GEOMETRICS.
- 9. ALL CONCRETE WORK SHALL BE INSTALLED TO THE COMPRESSIVE STRENGTH ESTABLISHED IN THE PROJECT GEOTECHNICAL REPORT. THE REPORT SHALL BE FOLLOWED IF THERE IS A DISCREPANCY WITHIN THESE DRAWINGS.
- 10. ALL ONSITE AND OFFSITE CURB AND GUTTER SHALL BE INSTALLED PER CURB AND GUTTER DETAILS WITHIN THIS DRAWING SET. 1/2 INCH EXPANSION JOINTS OF PRE-MOLDED BITUMASTIC EXPANSION JOINT. MATERIAL SHALL BE PROVIDED AT ALL RADIUS POINTS AND AT INTERVALS NOT TO EXCEED 50 FEET IN THE REMAINDER OF THE ON-SITE CURB AND GUTTER.
- 11. ALL SIGNS DEPICTED ON THESE PLANS ARE SHOWN FOR INFORMATION ONLY. ALL SIGNS SHALL BE PERMITTED SEPARATELY BY OTHERS
- 12. ALL TRAFFIC SIGNS SHALL CONFORM TO THE UNIFORM TRAFFIC CONTROL MANUAL AND/OR TO THE STATE DEPARTMENT OF TRANSPORTATION RULES AND REGULATIONS.
- 13. SITE CONTRACTOR SHALL PROVIDE AS-BUILT DRAWINGS UPON THE COMPLETION OF THE PROJECT.

ACCESSIBILITY NOTES

- 1. ALL HANDICAP ACCESSIBLE PARKING SIGNS AND STRIPING SHALL BE INSTALLED IN ACCORDANCE WITH THE AMERICANS WITH DISABILITY ACT (ADA) REQUIREMENTS. LOCAL CODES MAY GIVE ADDITIONAL DIRECTION WITH REGARD TO GEOMETRICS.
- 2. ALL HANDICAPPED PARKING SPACES AND ACCESS AISLES ADJACENT TO THE HANDICAP PARKING SPACES SHALL BE CONSTRUCTED TO A MAXIMUM SLOPE OF 2% IN ALL DIRECTIONS (THIS INCLUDES RUNNING SLOPE AND CROSS SLOPE).
- 3. IF AN ACCESSIBLE ROUTE FROM THE PUBLIC STREET OR SIDEWALK TO THE ENTRANCE IS TO BE PROVIDED IT SHALL BE CONSTRUCTED TO A MINIMUM OF 5' WIDE. THE RUNNING SLOPE OF THE ROUTE SHALL NOT EXCEED 5% AND THE CROSS SLOPE SHALL NOT EXCEED 2%.
- 4. SLOPES EXCEEDING 5% BUT LESS THAN 8% WILL REQUIRE A RAMP AND MUST CONFORM TO THE REQUIREMENTS FOR RAMP DESIGN (HANDRAILS, CURB, LANDINGS). NO RAMP SHALL EXCEED AN 8% RUNNING SLOPE OR 2% CROSS SLOPE.
- 5. IN THE CASE THAT A NEW SIDEWALK IS TO BE CONSTRUCTED IN THE PUBLIC R/W, THE RUNNING SLOPE OF THE SIDEWALK SHALL NOT EXCEED 5% AND THE CROSS SLOPE SHALL NOT EXCEED 2%. THIS STANDARD APPLIES ALSO TO CROSS WALKS WITHIN THE DRIVEWAY. SPECIAL ATTENTION SHALL BE PAID DURING STAKING TO ENSURE A 2% CROSS SLOPE IS MET.
- 6. IT SHALL BE THE RESPONSIBILITY OF THE GENERAL CONTRACTOR TO ENSURE THAT THE HANDICAP PARKING SPACES, ACCESSIBLE ROUTES, AND SIDEWALKS/CROSSWALKS ARE CONSTRUCTED TO MEET ADA REQUIREMENTS. INSTALLATIONS THAT ARE NON-COMPLIANT SHALL BE REMOVED AND REPLACED AT THE CONTRACTORS EXPENSE.
- ACCESSIBLE PARKING SHALL HAVE 98" VERTICAL CLEARANCE.
- 8. DETECTABLE WARNING STRIPS SHALL BE PLACED ON ALL RAMPS.
- 9. ALL ADA PARKING SPACES SHALL HAVE PROPER SIGNAGE POSTED TO DESIGNATE REGULAR SPACES AND VAN SPACES, AS WELL AS APPLICABLE LOCAL FINES FOR VIOLATIONS.

GRADING NOTES

- 1. THE PROJECT TOPOGRAPHIC SURVEY HAS BEEN PROVIDED BY ATWELL LLC. (THE ENGINEER SHALL NOT BE HELD RESPONSIBLE FOR THE ACCURACY OF THE SURVEY, OR FOR DESIGN ERRORS OR OMISSIONS AS A RESULT OF SURVEY INACCURACIES.)
- 2. SHOULD THE CONTRACTOR NOT ACCEPT THE EXISTING TOPOGRAPHY AS SHOWN ON THE PROJECT SURVEY OR THESE DESIGN DRAWINGS, HE MAY OPT TO HAVE A NEW TOPOGRAPHIC SURVEY PREPARED AT HIS OWN EXPENSE. 3. THE CONTRACTOR SHALL ADHERE TO ALL TERMS & CONDITIONS AS OUTLINED IN THE
- GENERAL NPDES PERMIT FOR STORMWATER DISCHARGE ASSOCIATED WITH CONSTRUCTION ACTIVITIES.
- 4. INFORMATION CONCERNING SITE SOIL CONDITIONS SHALL BE PROVIDED BY THE OWNER'S GEOTECHNICAL ENGINEER. THE PROJECT GEOTECHNICAL REPORT AND RECOMMENDATIONS THEREIN ARE CONSIDERED PART OF THE AUTHORIZED CONSTRUCTION DOCUMENTS . IN CASE OF CONFLICT OR DISCREPANCY, THE GEOTECHNICAL REPORT SHALL TAKE PRECEDENCE UNLESS SPECIFICALLY NOTED OTHERWISE ON THE DRAWINGS. THE CONTRACTOR SHALL NOTIFY THE ENGINEER IN WRITING OF ANY SUCH DISCREPANCY.
- 5. EARTHWORK FOR ALL BUILDING FOUNDATIONS AND SLABS SHALL BE IN ACCORDANCE WITH THE GEOTECHNICAL REPORT AND ARCHITECTURAL PLANS AND SPECIFICATIONS. 6. ALL FILL USED TO INCREASE THE ELEVATION OF THE FLOOR SLAB OR ANY FILL TO BE USED
- AS BACKFILL, SHALL BE CLEAN, SELECT, GRANULAR MATERIAL. PRIOR TO THE USE OF ANY GRANULAR FILL, GRADATION ANALYSIS SHALL BE PERFORMED ON REPRESENTATIVE SAMPLES OF THE FILL MATERIAL TO DETERMINE WHETHER THE MATERIAL IS SUITABLE FOR FILL. COMPACTED FILL SHALL BE PLACED IN ACCORDANCE WITH THE APPROVED GEOTECHNICAL REPORT FOR THE PROJECT.
- 7. ALL ROCKS, STUMPS, ROOTS, AND ORGANIC MATTER SHALL BE REMOVED TO A DEPTH OF TWO FEET MINIMUM BELOW THE BOTTOM OF THE BASE SECTIONS. THE CONTRACTOR SHALL CONTACT THE GEOTECHNICAL ENGINEER FOR DIRECTION BEFORE BURYING ROCK ONSITE.
- 8. ALL SOIL EROSION AND SEDIMENT SHALL BE CONTROLLED AND CONTAINED ON-SITE.
- 9. ALL SLOPES AND DISTURBED AREAS NOT COVERED BY BUILDING OR PAVEMENT SHALL BE GRADED UNIFORMLY AND SHALL RECEIVE A MINIMUM OF 4 INCHES OF TOPSOIL. THE CONTRACTOR SHALL IMPORT TOPSOIL IF NOT READILY AVAILABLE ONSITE. OPEN AREAS SHALL BE SEEDED, MULCHED, FERTILIZED AND WATERED TO PROVIDE AN UNIFORM STAND OF GRASS.
- 10. CONTRACTOR SHALL INSTALL SLOPE STABILIZATION FABRIC TO ALL SLOPES 2H:1V OR STEEPER AND SHALL MAINTAIN ALL SLOPE AREAS UNTIL THERE EXISTS A HEALTHY STAND OF GRASS.
- 11. THE CONTRACTOR SHALL PROVIDE POSITIVE DRAINAGE AWAY FROM THE BUILDINGS. 12. THE FLOW IN ALL EXISTING STORM SEWERS, STORM DRAINS, AND WATERWAYS SHALL BE
- MAINTAINED. 13. ALL SPOT ELEVATIONS SHALL BE TAKEN TO BE THE TOP OF PAVEMENT OR FINISHED GROUND UNLESS OTHERWISE NOTED. TC=TOP OF CURB ELEVATION
- MATCH=PROPOSED GRADE TO MATCH EXISTING GRADE TW=TOP OF RETAINING WALL ELEVATION;

- FG=FINISHED GRADE AT TOE OF WALL ELEVATION
- 14. CONTRACTOR SHALL VERIFY HORIZONTAL AND VERTICAL LOCATION OF ALL EXISTING STORM SEWER STRUCTURES, PIPES, AND ALL UTILITIES PRIOR TO CONSTRUCTION.
- 15. ALL PIPE LENGTHS SHOWN ON PLAN AND PROFILE VIEWS ARE BASED ON THE HORIZONTAL DISTANCE BETWEEN STRUCTURES.
- 16. THE CONTRACTOR SHALL COMPARE PLAN AND PROFILE STORM SEWER INFORMATION FOR DISCREPANCIES. IF ANY EXIST THE CONTRACTOR SHALL NOTIFY THE ENGINEER FOR CLARIFICATION.
- 17. PRECAST CONCRETE OR BRICK STRUCTURES MAY BE USED AT THE CONTRACTOR'S OPTION
- 18. ALL STORM PIPE CONNECTIONS AT MANHOLES SHALL BE WATER TIGHT
- 19. ALL STORM SEWER MANHOLE STRUCTURES IN PAVED AREAS SHALL BE INSTALLED OR ADJUSTED WITH TRAFFIC READY LIDS FLUSH WITH THE PAVEMENT. MANHOLE STRUCTURES IN UNPAVED AREAS SHALL BE INSTALLED FLUSH WITH FINISH GRADE.
- 20. ALL STORM STRUCTURES SHALL HAVE A SMOOTH UNIFORM POURED MORTAR INVERT FROM INVERT IN TO INVERT OUT.
- 21. ALL SYSTEM MANHOLES AND PIPES SHALL BE FLUSHED CLEAN PRIOR TO TURNING OVER TO THE OWNER.
- 22. THE CONTRACTOR SHALL LOCATE ALL EXISTING UNDERGROUND UTILITIES PRIOR TO COMMENCING WORK. EXISTING UNDERGROUND UTILITIES SHOWN ON THESE DRAWINGS ARE TAKEN FROM THE BEST SOURCES AVAILABLE (FIELD SURVEYS AND UTILITY MAPS) AND MAY NOT BE FULLY ACCURATE. AS SUCH, THE CONTRACTOR SHALL EXERCISE EXTREME CAUTION WHILE GRADING. ANY UTILITY RELOCATION DEEMED NECESSARY BUT NOT SHOWN ON THE APPROVED DRAWINGS SHALL BE BROUGHT TO THE ENGINEERS ATTENTION.
- 23. THE GRADING CONTRACTOR SHALL NOTIFY ALL UTILITY COMPANIES, ASSOCIATED GOVERNMENT DEPARTMENTS, AND THE OWNER'S REPRESENTATIVE PRIOR TO INTERRUPTION OF ANY UTILITY SERVICE. NOTIFICATION MUST BE MADE PER THE PROJECT SPECIFICATIONS. THE GRADING CONTRACTOR SHALL BE RESPONSIBLE FOR COORDINATION WITH AND ADHERENCE TO THE REQUIREMENTS OF EACH UTILITY COMPANY AND ANY GOVERNMENT UTILITY DEPARTMENT REGARDING SERVICE INTERRUPTION.

UTILITY NOTES

- 1. THE PROJECT UTILITY SURVEY HAVE BEEN PROVIDED BY ATWELL LLC.
- 2. THE CONTRACTOR SHALL HAVE A COPY OF THE APPROVED PLANS, A COPY OF THE DESIGN AND CONSTRUCTION STANDARDS AND SPECIFICATIONS, AND A COPY OF ALL PERMITS AND APPROVALS ON THE JOB.
- 3. ALL UTILITY TRENCHES ARE TO BE SLOPED OR BRACED AND SHEETED AS NECESSARY FOR THE SAFETY OF THE WORKERS AND FOR THE PROTECTION OF OTHER UTILITIES.
- 4. THE CONTRACTOR SHALL BE RESPONSIBLE FOR ALL PROJECT SAFETY INCLUDING, BUT NOT LIMITED TO, TRENCH EXCAVATION AND SHORINGS, TRAFFIC CONTROL, AND SECURITY. THE CONTRACTOR SHALL BE RESPONSIBLE FOR ALL SECURITY DURING CONSTRUCTION.
- 5. THE CONTRACTOR SHALL COMPLY WITH THE LATEST OSHA STANDARDS AND/OR DIRECTIVES WITH REGARD TO EXCAVATION AND TRENCHING PROCEDURES.
- 6. ALL FILL MATERIAL SHALL BE PLACED AND COMPACTED PRIOR TO UTILITY INSTALLATION.
- 7. THE CONTRACTOR SHALL PROVIDE RECORD DRAWINGS "AS-BUILT PLANS" AND "FINAL PLATS" (IF APPLICABLE) UPON COMPLETION OF THE PROJECT.
- 8. THE CONTRACTOR SHALL LOCATE ALL EXISTING UNDERGROUND UTILITIES PRIOR TO COMMENCING WORK. EXISTING UNDERGROUND UTILITIES SHOWN ON THESE DRAWINGS ARE TAKEN FROM THE BEST SOURCES AVAILABLE (FIELD SURVEYS AND UTILITY MAPS) AND MAY NOT BE FULLY ACCURATE. AS SUCH, THE CONTRACTOR SHALL EXERCISE EXTREME CAUTION WHILE GRADING. ANY UTILITY RELOCATION DEEMED NECESSARY BUT NOT SHOWN ON THE APPROVED DRAWINGS SHALL BE BROUGHT TO THE ENGINEERS ATTENTION.
- THE CONTRACTOR SHALL NOTIFY THE ENGINEER IMMEDIATELY REGARDING ANY UTILITY CONFLICTS, ADDITIONAL UTILITIES ENCOUNTERED, AND/OR ANY OTHER UTILITY INFORMATION WHICH MAY REQUIRE EXAMINATION.
- 10. THE CONTRACTOR SHALL COORDINATE WITH ALL UTILITY COMPANIES TO DETERMINE AND IMPLEMENT THEIR SPECIFIC INSTALLATION REQUIREMENTS AND SPECIFICATIONS.
- 11. THE CONTRACTOR SHALL CALL 811 AT LEAST 72 HOURS PRIOR TO EXCAVATION IN ORDER THAT UTILITIES BE FIELD LOCATED.
- 12. THE CONTRACTOR SHALL NOTIFY THE UTILITY AUTHORITY INSPECTOR 72 HOURS BEFORE CONNECTING TO ANY EXISTING UTILITY.
- 13. THE SITE CONTRACTOR SHALL COORDINATE SERVICE ROUTING OF ALL GAS, TELEPHONE, AND ELECTRICAL LINES WITH THE APPROPRIATE UTILITY COMPANY. ALL UTILITY CONSTRUCTION SHALL COMPLY WITH THE RESPECTIVE UTILITY'S STANDARDS AND SPECIFICATIONS.
- 14. THE CONTRACTOR SHALL COORDINATE WITH ALL UTILITY COMPANIES INVOLVED WITH REGARD TO RELOCATION OF OR ADJUSTMENTS TO EXISTING UTILITIES DURING CONSTRUCTION. THIS WORK SHALL BE PERFORMED IN A TIMELY FASHION AND WITH A MINIMAL DISRUPTION OF SERVICE.
- 15. THE CONTRACTOR SHALL REFER TO ARCHITECTURAL PLANS AND SPECIFICATIONS FOR THE PROPOSED LOCATION OF ALL WET AND DRY UTILITY ENTRANCES INTO THE BUILDING. CONTRACTOR SHALL COORDINATE INSTALLATION OF THE VARIOUS UTILITIES TO AVOID CONFLICTS AND ENSURE THAT THE PROPER DEPTHS ARE ACHIEVED.
- 16. ALL DRY UTILITY LINES SHALL BE INSTALLED IN ACCORDANCE WITH THE PROPER UTILITY COMPANY STANDARDS AND SPECIFICATIONS. THE CONTRACTOR SHALL COORDINATE THE INSTALLATION OF ALL DRY UTILITIES BY OTHERS.
- 17. THE CONTRACTOR SHALL REPAIR ALL DAMAGE TO EXISTING UTILITIES DURING CONSTRUCTION.
- 18. THE CONTRACTOR SHALL COORDINATE THE INSTALLATIONS OF WATER AND SANITARY SERVICES WITH THE LOCAL WATER AND SEWER PROVIDER. THE LOCAL WATER AND SEWER AUTHORITY STANDARD SPECIFICATIONS AND DETAILS SHALL GOVERN ALL WATER AND SANITARY SEWER CONSTRUCTION.
- 19. THE CONTRACTOR SHALL BE RESPONSIBLE FOR FIELD VERIFYING THE EXACT LOCATION, SIZE, AND MATERIAL OF ANY EXISTING WATER AND/OR SEWER FACILITY PROPOSED FOR CONNECTION OR USE BY THIS PROJECT. THE RELOCATION OF ALL WATER/SEWER FACILITIES SHALL BE COORDINATED WITH THE RESPECTIVE UTILITY COMPANY.
- 20. PRIOR TO CONSTRUCTION, THE CONTRACTOR SHALL TELEVISE EXISTING SANITARY SEWER LINE FROM THE POINT OF CONNECTION THROUGH THE NEXT SUCCESSIVE DOWNSTREAM RUN OF PIPE. THE CONTRACTOR SHALL ALSO TELEVISE ALL NEWLY INSTALLED SANITARY SEWER PIPE TO ENSURE LINES AND GRADES HAVE BEEN MET.
- 21. THE CONTRACTOR SHALL MAINTAIN A MINIMUM OF 18" VERTICAL SEPARATION BETWEEN SANITARY, WATER, STORM, AND PRIVATE UTILITY LINES. MEASUREMENTS SHALL BE TAKEN FROM THE NEAREST EDGE OF THE UTILITIES IN QUESTION.

- 22. THE MINIMUM HORIZONTAL SEPARATION BETWEEN THE WATER AND SEWER SERVICES SHALL BE 8'. THE MINIMUM VERTICAL SEPARATIONS SHALL BE 18" 23. SANITARY SEWER PIPE SLOPE SHALL BE MEASURED FROM CENTER OF MANHOLE TO
- CENTER OF MANHOLE.
- 24. ALL MANHOLES REQUIRE KOR-N-SEAL OR EQUAL RUBBER BOOTS. 25. TOPS FOR SANITARY SEWER MANHOLES PLACED WITHIN PAVED AREAS SHALL BE INSTALLED WITH TRAFFIC READY FRAMES AND SHALL MATCH THE FINISHED PAVEMENT ELEVATIONS TOPS FOR MANHOLES PLACED WITHIN GRASSED AREAS SHALL MATCH FINISHED GRADE ELEVATIONS. ALL EXISTING MANHOLES & UTILITY BOXES SHALL BE ADJUSTED AS NECESSARY TO MATCH FINISHED GRADING.
- 26. ALL SANITARY MANHOLES AND PIPE SHALL BE FLUSHED CLEAN OF DEBRIS PRIOR TO TURNING SYSTEM OVER TO OWNER.
- 27. ALL FIRE HYDRANTS SHALL CONFORM TO LOCAL REQUIREMENTS. 28. THRUST BLOCKS ARE REQUIRED WHEREVER PIPE CHANGES DIRECTION (TEES, BENDS, ETC.).
- 29. GRAVITY SEWER LINE MATERIAL SHALL BE PVC (SDR35) OR DIP (CLASS 350). THE PRIMARY ELECTRIC SERVICE SHALL BE PROVIDED BY THE LOCAL POWER PROVIDER. THIS INCLUDES THE TRANSFORMER, PAD, TRENCHING, BACKFILL AND COMPACTION. THE CONTRACTOR SHALL BE RESPONSIBLE FOR THE INSTALLATION OF THE SECONDARY SERVICE. THE CONTRACTOR SHALL COORDINATE THE INSTALLATION OF BOTH SERVICES. 31. THE GAS SERVICE UP TO THE GAS METER SHALL BE PROVIDED BY THE LOCAL GAS PROVIDER. THE CONTRACTOR SHALL COORDINATE THE INSTALLATION OF THE GAS
- SERVICE.
- 32. THE GAS AND UNDERGROUND POWER LINES ARE SHOWN FOR INFORMATION PURPOSES ONLY. EXACT LOCATIONS SHALL BE FIELD DETERMINED DURING CONSTRUCTION.


EROSION NOTES

- 4. ALL EROSION AND SEDIMENTATION CONTROL MEASURES SHALL CONFORM TO THE LATEST EROSION AND SEDIMENT CONTROL REGULATIONS FOR ASSOCIATED FEDERAL, REGIONAL, AND LOCAL REGULATORY AGENCIES.
- 5. ALL EROSION CONTROL MEASURES SHALL MEET THE REQUIREMENTS AND THE SPECIFICATIONS CONTAINED WITHIN THE CONSTRUCTION DETAILS UNLESS AN EQUAL PRODUCT HAS BEEN PRESENTED TO AND APPROVED BY THE OWNER OR THE OWNER'S REPRESENTATIVE.
- THE ESCAPE OF SEDIMENT FROM THE SITE SHALL BE PREVENTED BY THE INSTALLATION OF EROSION CONTROL MEASURES AND PRACTICES PRIOR TO LAND DISTURBING ACTIVITIES. THESE MEASURES SHALL BE MAINTAINED THROUGHOUT THE ENTIRE DURATION OF LAND DISTURBING ACTIVITIES.
- 7. THE CONTRACTOR SHALL PROTECT ANY BORDERING OR ADJACENT DRAINAGE COURSE AND SHALL REMOVE ANY INTRUDING CONSTRUCTION DEBRIS OR SPOIL MATERIAL IN AN EXPEDITIOUS MANNER.
- 8. THE LIMITS OF LAND DISTURBANCE SHALL BE CLEARLY MARKED AT THE OUTSET OF CONSTRUCTION AND SHALL REMAIN IN PLACE THROUGHOUT THE DURATION OF THE CONSTRUCTION ACTIVITY. NO LAND DISTURBANCE SHALL OCCUR OUTSIDE THE APPROVED LIMITS AS INDICATED ON THE APPROVED EROSION CONTROL DRAWINGS. IF WETLANDS EXIST ON-SITE, ALL CLEARING MUST BE PERFORMED IN ACCORDANCE WITH THE APPROVED CORPS WETLANDS PERMIT.
- 9. A CONSTRUCTION ENTRANCE/EXIT SHALL BE INSTALLED AT THE OUTSET OF CONSTRUCTION AND SHALL BE MAINTAINED APPROPRIATELY IN ORDER TO PREVENT TRACKING ONTO PUBLIC ROADWAYS. ALL MATERIALS SPILLED ONTO A PUBLIC ROADWAY OR INTO A PUBLIC STORM SEWER SHALL BE REMOVED IMMEDIATELY.
- VEGETATION.
- 12. THE CONTRACTOR SHALL REMOVE AND DISPOSE OF ACCUMULATED SILT FROM EACH RESPECTIVE EROSION CONTROL MEASURE IN ACCORDANCE WITH THE NOTES AND DETAILS ON THESE DRAWINGS.

- 15. ADDITIONAL EROSION CONTROL MEASURES MAY BE REQUIRED SHOULD INTERIM DRAINAGE CONDITIONS DIFFER FROM THE APPROVED FINAL CONDITIONS. THE CONTRACTOR SHALL MAKE ADJUSTMENTS ACCORDINGLY IN ORDER THAT SEDIMENT NOT LEAVE THE SITE. 16. THE CONTRACTOR SHALL KEEP AN ON-SITE DAILY LOG OF THE MAINTENANCE OF ALL
- ALL TIMES.

- 1. THE PROJECT TOPOGRAPHIC SURVEY HAS BEEN PROVIDED BY COMPASS LAND SURVEYING. (THE ENGINEER SHALL NOT BE HELD RESPONSIBLE FOR THE ACCURACY OF THE SURVEY, OR FOR DESIGN ERRORS OR OMISSIONS AS A RESULT OF SURVEY INACCURACIES.) 2. THE OWNER SHALL ALLOW AND MAINTAIN OFF-STREET PARKING FOR WORKERS ON THE SUBJECT PROPERTY THROUGHOUT CONSTRUCTION.
- 3. A COPY OF THE APPROVED LAND DISTURBANCE PLAN AND PERMIT SHALL BE PRESENT ONSITE WHENEVER LAND DISTURBANCE ACTIVITY IS IN PROGRESS.

- 10. ONCE A CONSTRUCTION EXIT HAS BEEN APPROPRIATELY INSTALLED, APPROPRIATE PERIMETER EROSION CONTROL AND STORMWATER MEASURES SHALL BE INSTALLED PRIOR TO FURTHER CONSTRUCTION.
- 11. ALL SEDIMENT CONTROL MEASURES SHALL BE MAINTAINED UNTIL ALL DISTURBED AREAS HAVE BEEN STABILIZED WITH EITHER PERMANENT HARD SURFACE GROUND COVER
- 13. ALL DISTURBED AREAS LEFT EXPOSED FOR A PERIOD GREATER THAN 14 DAYS SHALL BE STABILIZED WITH TEMPORARY SEEDING.
- 14. ADDITIONAL EROSION AND SEDIMENT CONTROL MEASURES SHALL BE INSTALLED IF DEEMED NECESSARY BY ON-SITE INSPECTION.
- EROSION CONTROL MEASURES. THE LOG SHALL BE MADE AVAILABLE FOR INSPECTION AT

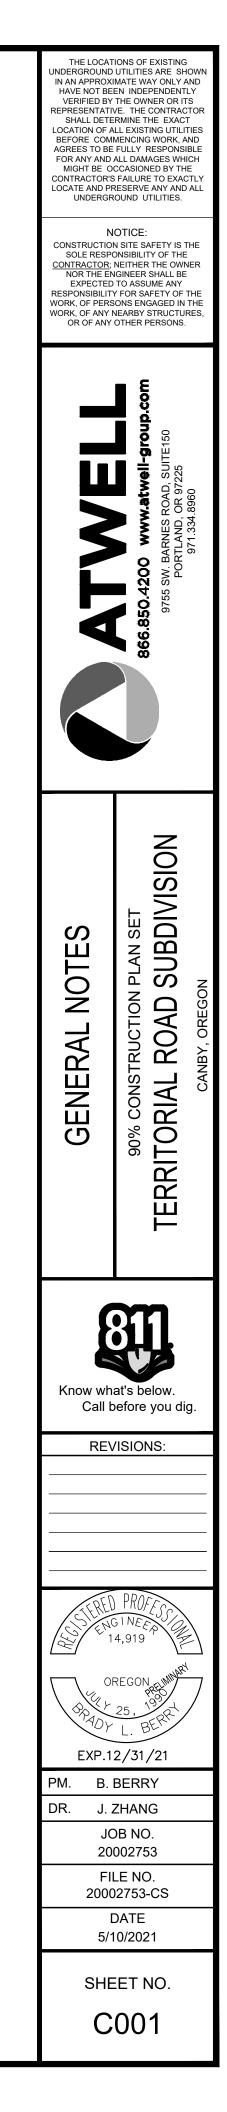

EROSION AND SEDIMENT CONTROL PLAN

BMP MATRIX FOR CONSTRUCTION PHASES

REFER TO DEQ GUIDANCE MANUAL FOR A COMPREHENSIVE LIST OF AVAILABLE BMP'S

		MASS	UTILITY	BUILDING	FINAL	WET WEATHER
	CLEARING	GRADING	INSTALLATION	CONSTRUCTION	STABILIZATION	(OCT. 1 - MAY 31ST)
EROSION PREVENTION	1	1				
PRESERVE NATURAL VEGETATION						
GROUND COVER					Х	Х
HYDRAULIC APPLICATIONS					Х	Х
PLASTIC SHEETING						х
MATTING						
DUST CONTROL			Х	Х	X	X
TEMPORARY/ PERMANENT SEEDING			Х	X	X	X
BUFFER ZONE						
DTHER:						
SEDIMENT CONTROL						
SEDIMENT FENCE (PERIMETER)						
SEDIMENT FENCE (INTERIOR)						
STRAW WATTLES			Х	X	Х	Х
FILTER BERM						
INLET PROTECTION			Х	Х	Х	X
DEWATERING						
SEDIMENT TRAP						
NATURAL BUFFER ENCROACHMENT						
DTHER:						
RUN OFF CONTROL						
CONSTRUCTION ENTRANCE						
PIPE SLOPE DRAIN						
OUTLET PROTECTION						
SURFACE ROUGHENING						
CHECK DAMS						
DTHER:						
POLLUTION PREVENTION						
PROPER SIGNAGE			Х	X	Х	Х
HAZ WASTE MGMT			Х	Х	Х	Х
SPILL KIT ON-SITE			Х	X	Х	Х
CONCRETE WASHOUT AREA			Х	Х		X
DTHER:						

SIGNIFIES ADDITIONAL BMP'S REQUIRED FOR WORK WITHIN 50' OF WATER OF THE STATE. SIGNIFIES BMP THAT WILL BE INSTALLED PRIOR TO ANY GROUND DISTURBING ACTIVITY.

- THE PERMITTEE IS REQUIRED TO MEET ALL THE CONDITIONS OF THE 1200C PERMIT. THIS ESCP AND GENERAL CONDITIONS HAVE BEEN DEVELOPED TO FACILITATE COMPLIANCE WITH THE 1200C PERMIT REQUIREMENTS. IN CASES OF DISCREPANCIES OR OMISSIONS, THE 1200C PERMIT REQUIREMENTS SUPERCEDE REQUIREMENTS OF THIS PLAN
- CONTRACTOR SHALL SUBMIT NOTICE OF TERMINATION TO DEQ AT THE END OF THE 1200-C PERMIT COVERAGE ONCE ALL SOIL DISTURBANCE ACTIVITIES HAVE BEEN COMPLETED AND FINAL STABILIZATION OF EXPOSED SOILS HAS OCCURRED.

INSPECTION FREQUENCY

ATTENTION EXCAVATORS

OREGON LAW REQUIRES YOU TO FOLLOW

RULES ADOPTED BY THE OREGON UTILITY

FORTH IN OAR 952-001-0010 THROUGH OAR

952-001-0090. YOU MAY OBTAIN COPIES OF

503-232-1987. IF YOU HAVE ANY QUESTIONS

ABOUT THE RULES, YOU MAY CONTACT THE

CENTER. YOU MUST NOTIFY THE CENTER AT

LEAST TWO BUSINESS DAYS, BEFORE

COMMENCING AN EXCAVATION. CALL

503-246-6699.

MINIMUM FREQUENCY

DAILY WHEN STORMWATER RUNOFF, INCLUDING

AT LEAST ONCE EVERY FOURTEEN (14) CALENDAR

DAYS REGARDLESS OF WHETHER STORMWATER

ONCE TO ENSURE THAT EROSION AND SEDIMENT

CONTROL MEASURES ARE IN WORKING ORDER. ANY

IF PRACTICAL, INSPECTIONS MUST OCCUR DAILY AT A

MONTHLY. RESUME MONITORING IMMEDIATELY UPON

MELT, OR WHEN WEATHER CONDITIONS MAKE

RELEVANT AND ACCESSIBLE DISCHARGE POINT OR

NECESSARY MAINTENANCE AND REPAIR MUST BE

RUNOFF FROM SNOW MELT, IS OCCURRING.

RUNOFF IS OCCURRING.

ONCE EVERY MONTH

DOWNSTREAM LOCATION.

DISCHARGES LIKELY.

MADE PRIOR TO LEAVING THE SITE.

NOTIFICATION CENTER. THOSE RULES ARE SET

THESE RULES FROM THE CENTER BY CALLING

RATIONALE STATEMENT

A COMPREHENSIVE LIST OF AVAILABLE BEST MANAGEMENT PRACTICES (BMP) OPTIONS BASED ON DEQ'S GUIDANCE MANUAL HAS BEEN REVIEWED TO COMPLETE THIS EROSION AND SEDIMENT CONTROL PLAN. SOME OF THE ABOVE LISTED BMP'S WERE NOT CHOSEN BECAUSE THEY WERE DETERMINED TO NOT EFFECTIVELY MANAGE EROSION PREVENTION AND SEDIMENT CONTROL FOR THIS PROJECT BASED ON SPECIFIC SITE CONDITIONS, INCLUDING SOIL CONDITIONS TOPOGRAPHIC CONSTRAINTS, ACCESSIBILITY TO THE SITE, AND OTHER RELATED CONDITIONS, AS THE PROJECT PROGRESSES AND THERE IS A NEED TO REVISE THE ESC PLAN, AN ACTION PLAN WILL BE SUBMITTED.

INITIAL

SITE CONDITION

. ACTIVE PERIOD

2. PRIOR TO THE SITE BECOMING INACTIVE OR IN

. INACTIVE PERIODS GREATER THAN FOURTEEN (14)

4. PERIODS DURING WHICH THE SITE IS INACCESSIBLE


5. PERIODS DURING WHICH DISCHARGE IS UNLIKELY

ANTICIPATION OF SITE INACCESSIBILITY.

CONSECUTIVE CALENDAR DAYS.

DUE TO INCLEMENT WEATHER.

DUE TO FROZEN CONDITIONS.

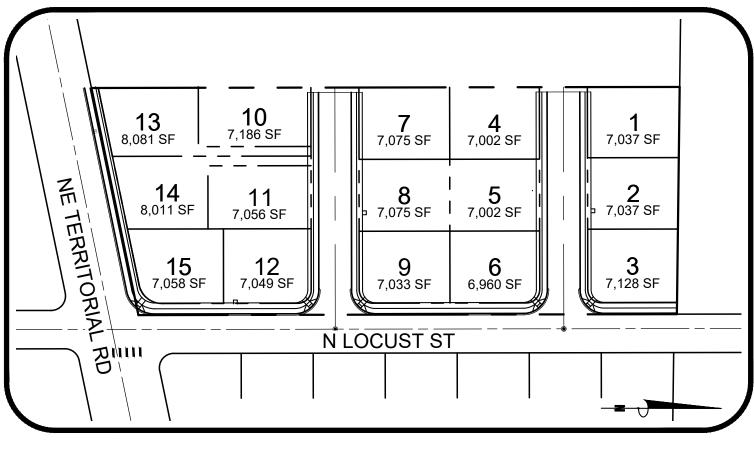

STANDARD DEQ ESCP NOTES

- 1. ONCE KNOWN, INCLUDE A LIST OF ALL CONTRACTORS THAT WILL ENGAGE IN CONSTRUCTION ACTIVITIES ON SITE, AND THE AREAS OF THE SITE WHERE THE CONTRACTOR(S) WILL ENGAGE INSTALLED. (SEE SECTIONS 2.2.17 AND 2.2.18) IN CONSTRUCTION ACTIVITIES. REVISE THE LIST AS APPROPRIATE UNTIL PERMIT COVERAGE 28. PROVIDE A DEWATERING PLAN FOR ACCUMULATED WATER FROM PRECIPITATION AND IS TERMINATED (SECTION 4.4.C.I). IN ADDITIONS, INCLUDE A LIST OF ALL PERSONNEL (BY UNCONTAMINATED GROUNDWATER SEEPAGE DUE TO SHALLOW EXCAVATION ACTIVITIES. NAME AND POSITION) THAT ARE RESPONSIBLE FOR THE DESIGN, INSTALLATION AND (SEE SECTION 2.4) MAINTENANCE OF STORMWATER CONTROL MEASURES (E.G. ESCP DEVELOPER, BMP 29. IMPLEMENT THE FOLLOWING BMPS WHEN APPLICABLE: WRITTEN SPILL PREVENTION AND INSTALLER (SECTION 4.10), AS WELL AS THEIR INDIVIDUAL RESPONSIBILITIES. (SECTION RESPONSE PROCEDURES, EMPLOYEE TRAINING ON SPILL PREVENTION AND PROPER 4.4.C.II) DISPOSAL PROCEDURES, SPILL KITS IN ALL VEHICLES, REGULAR MAINTENANCE SCHEDULE VISUAL MONITORING INSPECTION REPORTS MUST BE MADE IN ACCORDANCE WITH DEQ FOR VEHICLES AND MACHINERY, MATERIAL DELIVERY AND STORAGE CONTROLS, TRAINING 1200-C PERMIT REQUIREMENTS. (SECTION 6.5) AND SIGNAGE, AND COVERED STORAGE AREAS FOR WASTE AND SUPPLIES. (SECTION 2.3)
- INSPECTION LOGS MUST BE KEPT IN ACCORDANCE WITH DEQ'S 1200-C PERMIT REQUIREMENTS. (SECTION 6.5.Q) 4. RETAIN A COPY OF THE ESCP AND ALL REVISIONS ON SITE AND MAKE IT AVAILABLE ON
- REQUEST TO DEQ, AGENT, OR THE LOCAL MUNICIPALITY. (SECTION 4.7) THE PERMIT REGISTRANT MUST IMPLEMENT THE ESCP. FAILURE TO IMPLEMENT ANY OF THE CONTROL MEASURES OR PRACTICES DESCRIBED IN THE ESCP IS A VIOLATION OF THE PERMIT. (SECTIONS 4 AND 4.11)
- THE ESCP MUST BE ACCURATE AND REFLECT SITE CONDITIONS. (SECTION 4.8) SUBMISSION OF ALL ESCP REVISIONS IS NOT REQUIRED. SUBMITTAL OF THE ESCP REVISIONS IS ONLY UNDER SPECIFIC CONDITIONS.SUBMIT ALL NECESSARY REVISION TO DEQ OR AGENT WITHIN 10 DAYS. (SECTION 4.9)
- SEQUENCE CLEARING AND GRADING TO THE MAXIMUM EXTENT PRACTICAL TO PREVENT EXPOSED INACTIVE AREAS FROM BECOMING A SOURCE OF EROSION. (SECTION 2.2.2) CREATE SMOOTH SURFACES BETWEEN SOIL SURFACE AND EROSION AND SEDIMENT CONTROLS TO PREVENT STORMWATER FROM BYPASSING CONTROLS AND PONDING.
- (SECTION 2.2.3)
- RIPARIAN AREAS AND VEGETATION INCLUDING IMPORTANT TREES AND ASSOCIATED ROOTING ZONES, AND VEGETATION AREAS TO BE PRESERVED. IDENTIFY VEGETATIVE BUFFER ZONES BETWEEN THE SITE AND SENSITIVE AREAS (E.G., WETLANDS), AND OTHER AREAS TO BE PRESERVED, ESPECIALLY IN PERIMETER AREAS. (SECTION 2.2.1) RE-VEGETATE OPEN AREAS WHEN PRACTICABLE BEFORE AND AFTER GRADING OR CONSTRUCTION. IDENTIFY THE TYPE OF VEGETATIVE SEED MIX USED. (SECTION 2.2.5)
- 10. IDENTIFY, MARK, AND PROTECT (BY CONSTRUCTION FENCING OR OTHER MEANS) CRITICAL 11. PRESERVE EXISTING VEGETATION WHEN PRACTICAL AND RE-VEGETATE OPEN AREAS.
- 12. MAINTAIN AND DELINEATE ANY EXISTING NATURAL BUFFER WITHIN THE 50-FEET OF WATERS OF THE STATE. (SECTION 2.2.4) 13. INSTALL PERIMETER SEDIMENT CONTROL, INCLUDING STORM DRAIN INLET PROTECTION AS
- WELL AS ALL SEDIMENT BASINS, TRAPS, AND BARRIERS PRIOR TO LAND DISTURBANCE.
- (SECTIONS 2.1.3) 14. CONTROL BOTH PEAK FLOW RATES AND TOTAL STORMWATER VOLUME, TO MINIMIZE EROSION AT OUTLETS AND DOWNSTREAM CHANNELS AND STREAM BANKS. (SECTIONS 2.1.1.
- AND 2.2.16) 15. CONTROL SEDIMENT AS NEEDED ALONG THE SITE PERIMETER AND AT ALL OPERATIONAL INTERNAL STORM DRAIN INLETS AT ALL TIMES DURING CONSTRUCTION, BOTH INTERNALLY AND AT THE SITE BOUNDARY. (SECTIONS 2.2.6 AND 2.2.13)
- 16. ESTABLISH CONCRETE TRUCK AND OTHER CONCRETE EQUIPMENT WASHOUT AREAS BEFORE BEGINNING CONCRETE WORK. (SECTION 2.2.14)
- CLEANUP RELEASED SEDIMENTS. (SECTION 2.2.19) 17. APPLY TEMPORARY AND/OR PERMANENT SOIL STABILIZATION MEASURES IMMEDIATELY ON 40. DOCUMENT ANY PORTION(S) OF THE SITE WHERE LAND DISTURBING ACTIVITIES HAVE ALL DISTURBED AREAS AS GRADING PROGRESSES. TEMPORARY OR PERMANENT PERMANENTLY CEASED OR WILL BE TEMPORARILY INACTIVE FOR 14 OR MORE CALENDAR STABILIZATIONS MEASURES ARE NOT REQUIRED FOR AREAS THAT ARE INTENDED TO BE LEFT DAYS. (SECTION 6.5.F.) UNVEGETATED, SUCH AS DIRT ACCESS ROADS OR UTILITY POLE PADS.(SECTIONS 2.2.20 AND 41. PROVIDE TEMPORARY STABILIZATION FOR THAT PORTION OF THE SITE WHERE 2.2.21)
- 18. ESTABLISH MATERIAL AND WASTE STORAGE AREAS, AND OTHER NON-STORMWATER CONTROLS. (SECTION 2.3.7)
- 19. KEEP WASTE CONTAINER LIDS CLOSED WHEN NOT IN USE AND CLOSE LIDS AT THE END OF THE BUSINESS DAY FOR THOSE CONTAINERS THAT ARE ACTIVELY USED THROUGHOUT THE DAY. FOR WASTE CONTAINERS THAT DO NOT HAVE LIDS, PROVIDE EITHER (1) COVER (E.G., A TARP, PLASTIC SHEETING, TEMPORARY ROOF) TO PREVENT EXPOSURE OF WASTES TO PRECIPITATION, OR (2) A SIMILARLY EFFECTIVE MEANS DESIGNED TO PREVENT THE DISCHARGE OF POLLUTANTS (E.G., SECONDARY CONTAINMENT). (SECTION 2.3.7) 20. PREVENT TRACKING OF SEDIMENT ONTO PUBLIC OR PRIVATE ROADS USING BMPS SUCH AS:
- CONSTRUCTION ENTRANCE, GRAVELED (OR PAVED) EXITS AND PARKING AREAS, GRAVEL ALL UNPAVED ROADS LOCATED ONSITE, OR USE AN EXIT TIRE WASH. THESE BMPS MUST BE IN PLACE PRIOR TO LAND- DISTURBING ACTIVITIES. (SECTION 2.2.7) 21. WHEN TRUCKING SATURATED SOILS FROM THE SITE, EITHER USE WATER-TIGHT TRUCKS OR
- DRAIN LOADS ON SITE. (SECTION 2.2.7.F)
- 22. CONTROL PROHIBITED DISCHARGES FROM LEAVING THE CONSTRUCTION SITE, I.E., CONCRETE WASH-OUT, WASTEWATER FROM CLEANOUT OF STUCCO, PAINT AND CURING COMPOUNDS. (SECTIONS 1.5 AND 2.3.9)
- 23. ENSURE THAT STEEP SLOPE AREAS WHERE CONSTRUCTION ACTIVITIES ARE NOT OCCURRING ARE NOT DISTURBED. (SECTION 2.2.10) 24. PREVENT SOIL COMPACTION IN AREAS WHERE POST-CONSTRUCTION INFILTRATION
- FACILITIES ARE TO BE INSTALLED. (SECTION 2.2.12)
- 25. USE BMPS TO PREVENT OR MINIMIZE STORMWATER EXPOSURE TO POLLUTANTS FROM SPILLS; VEHICLE AND EQUIPMENT FUELING, MAINTENANCE, AND STORAGE; OTHER CLEANING 4. THE ESC FACILITIES SHOWN ON THIS PLAN MUST BE CONSTRUCTED IN CONJUNCTION WITH AND MAINTENANCE ACTIVITIES; AND WASTE HANDLING ACTIVITIES. THESE POLLUTANTS ALL CLEARING AND GRADING ACTIVITIES, AND IN SUCH A MANNER AS TO ENSURE THAT INCLUDE FUEL, HYDRAULIC FLUID, AND OTHER OILS FROM VEHICLES AND MACHINERY, AS SEDIMENT AND SEDIMENT LADEN WATER DOES NOT ENTER THE DRAINAGE SYSTEM, WELL AS DEBRIS, FERTILIZER, PESTICIDES AND HERBICIDES, PAINTS, SOLVENTS, CURING ROADWAYS, OR VIOLATE APPLICABLE WATER STANDARDS. COMPOUNDS AND ADHESIVES FROM CONSTRUCTION OPERATIONS. (SECTIONS 2.2.15 AND 2.3)





VICINITY MAP 1" = 400'

- 26. PROVIDE PLANS FOR SEDIMENTATION BASINS THAT HAVE BEEN DESIGNED PER SECTION 2.2.17 AND STAMPED BY AN OREGON PROFESSIONAL ENGINEER. (SEE SECTION 2.2.17.A) 27. IF ENGINEERED SOILS ARE USED ON SITE, A SEDIMENTATION BASIN/IMPOUNDMENT MUST BE
- 30. USE WATER, SOIL-BINDING AGENT OR OTHER DUST CONTROL TECHNIQUE AS NEEDED TO AVOID WIND-BLOWN SOIL. (SECTION 2.2.9) 31. THE APPLICATION RATE OF FERTILIZERS USED TO REESTABLISH VEGETATION MUST FOLLOW
- MANUFACTURER'S RECOMMENDATIONS TO MINIMIZE NUTRIENT RELEASES TO SURFACE WATERS. EXERCISE CAUTION WHEN USING TIME-RELEASE FERTILIZERS WITHIN ANY WATERWAY RIPARIAN ZONE. (SECTION 2.3.5)
- 32. IF AN ACTIVE TREATMENT SYSTEM (FOR EXAMPLE, ELECTRO-COAGULATION, FLOCCULATION, FILTRATION, ETC.) FOR SEDIMENT OR OTHER POLLUTANT REMOVAL IS EMPLOYED, SUBMIT AN OPERATION AND MAINTENANCE PLAN (INCLUDING SYSTEM SCHEMATIC, LOCATION OF SYSTEM, LOCATION OF INLET, LOCATION OF DISCHARGE, DISCHARGE DISPERSION DEVICE DESIGN, AND A SAMPLING PLAN AND FREQUENCY) BEFORE OPERATING THE TREATMENT SYSTEM, OBTAIN ENVIRONMENTAL MANAGEMENT PLAN APPROVAL FROM DEQ BEFORE OPERATING THE TREATMENT SYSTEM. OPERATE AND MAINTAIN THE TREATMENT SYSTEM. ACCORDING TO MANUFACTURER'S SPECIFICATIONS. (SECTION 1.2.9)
- 33. TEMPORARILY STABILIZE SOILS AT THE END OF THE SHIFT BEFORE HOLIDAYS AND WEEKENDS, IF NEEDED, THE REGISTRANT IS RESPONSIBLE FOR ENSURING THAT SOILS ARE STABLE DURING RAIN EVENTS AT ALL TIMES OF THE YEAR. (SECTION 2.2)
- 34. AS NEEDED BASED ON WEATHER CONDITIONS, AT THE END OF EACH WORKDAY SOIL STOCKPILES MUST BE STABILIZED OR COVERED, OR OTHER BMPS MUST BE IMPLEMENTED TO PREVENT DISCHARGES TO SURFACE WATERS OR CONVEYANCE SYSTEMS LEADING TO SURFACE WATERS. (SECTION 2.2.8)
- 35. SEDIMENT FENCE: REMOVE TRAPPED SEDIMENT BEFORE IT REACHES ONE THIRD OF THE ABOVE GROUND FENCE HEIGHT AND BEFORE FENCE REMOVAL. (SECTION 2.1.5.B)
- 36. OTHER SEDIMENT BARRIERS (SUCH AS BIOBAGS): REMOVE SEDIMENT BEFORE IT REACHES TWO INCHES DEPTH ABOVE GROUND HEIGHT AND BEFORE BMP REMOVAL. (SECTION 2.1.5.C) 37. CATCH BASINS: CLEAN BEFORE RETENTION CAPACITY HAS BEEN REDUCED BY FIFTY
- PERCENT. SEDIMENT BASINS AND SEDIMENT TRAPS: REMOVE TRAPPED SEDIMENTS BEFORE DESIGN CAPACITY HAS BEEN REDUCED BY FIFTY PERCENT AND AT COMPLETION OF PROJECT. (SECTION 2.1.5.D)
- 38. WITHIN 24 HOURS, SIGNIFICANT SEDIMENT THAT HAS LEFT THE CONSTRUCTION SITE, MUST BE REMEDIATED. INVESTIGATE THE CAUSE OF THE SEDIMENT RELEASE AND IMPLEMENT STEPS TO PREVENT A RECURRENCE OF THE DISCHARGE WITHIN THE SAME 24 HOURS. ANY IN-STREAM CLEAN-UP OF SEDIMENT SHALL BE PERFORMED ACCORDING TO THE OREGON DEPARTMENT OF STATE LANDS REQUIRED TIMEFRAME. (SECTION 2.2.19.A)
- 39. THE INTENTIONAL WASHING OF SEDIMENT INTO STORM SEWERS OR DRAINAGE WAYS MUST NOT OCCUR. VACUUMING OR DRY SWEEPING AND MATERIAL PICKUP MUST BE USED TO
- CONSTRUCTION ACTIVITIES CEASE FOR 14 DAYS OR MORE WITH A COVERING OF BLOWN STRAW AND A TACKIFIER, LOOSE STRAW, OR AN ADEQUATE COVERING OF COMPOST MULCH UNTIL WORK RESUMES ON THAT PORTION OF THE SITE. (SECTION 2.2.20)
- 42. DO NOT REMOVE TEMPORARY SEDIMENT CONTROL PRACTICES UNTIL PERMANENT VEGETATION OR OTHER COVER OF EXPOSED AREAS IS ESTABLISHED. ONCE CONSTRUCTION IS COMPLETE AND THE SITE IS STABILIZED, ALL TEMPORARY EROSION CONTROLS AND RETAINED SOILS MUST BE REMOVED AND DISPOSED OF PROPERLY, UNLESS NEEDED FOR LONG TERM USE FOLLOWING TERMINATION OF PERMIT COVERAGE. (SECTION 2.2.21)

LOCAL JURISDICTION EROSION CONTROL NOTES:

- OWNER OR DESIGNATED PERSON SHALL BE RESPONSIBLE FOR PROPER INSTALLATION AND MAINTENANCE OF ALL EROSION AND SEDIMENT CONTROL (ESC) MEASURES, IN ACCORDANCE WITH LOCAL, STATE, AND FEDERAL REGULATIONS.
- 2. THE IMPLEMENTATION OF THESE ESC PLANS AND CONSTRUCTION, MAINTENANCE, REPLACEMENT, AND UPGRADING OF THESE ESC FACILITIES IS THE RESPONSIBILITY OF THE CONTRACTOR UNTIL ALL CONSTRUCTION IS COMPLETED AND APPROVED BY THE LOCAL JURISDICTION, AND VEGETATION/LANDSCAPING IS ESTABLISHED. THE DEVELOPER SHALL BE RESPONSIBLE FOR MAINTENANCE AFTER THE PROJECT IS APPROVED UNTIL THE LOTS ARE SOLD
- 3. THE BOUNDARIES OF THE CLEARING LIMITS SHOWN ON THIS PLAN SHALL BE CLEARLY MARKED IN THE FIELD PRIOR TO CONSTRUCTION. DURING THE CONSTRUCTION PERIOD, NO DISTURBANCE BEYOND THE CLEARING LIMITS SHALL BE PERMITTED. THE MARKINGS SHALL BE MAINTAINED BY THE APPLICANT/CONTRACTOR FOR THE DURATION OF CONSTRUCTION.

OWNER/DEVELOPER VENTURE PROPERTIES, INC. 4230 GALEWOOD ST. STE 100 LAKE OSWEGO, OR 97035

CONTACT: AL JECK PHONE: 503.387.7557 EMAIL: AL@VENTUREPROP.COM

CIVIL ENGINEERING FIRM

ATWELL, LLC. 9755 SW BARNES ROAD, SUITE 150 PORTLAND, OR 97225 CONTACT: BRADY BERRY, PE PHONE: 971.334.8962 EMAIL: BBERRY@ATWELL-GROUP.COM

PROJECT LOCATION:

102 NE TERRITORIAL RD CANBY, OREGON CLACKAMAS COUNTY LATITUDE = 45.277701 LONGITUDE = -122.69210

PROJECT DESCRIPTION

TAX LOT 401 (CLACKAMAS COUNTY TAX MAP) LOCATED IN SECTION 28C, TOWNSHIP 3 SOUTH, RANGE 1 EAST, W.M. CLACKAMAS COUNTY, CITY OF CANBY OREGON

THE ESC FACILITIES SHOWN ON THIS PLAN ARE MINIMUM REQUIREMENTS FOR ANTICIPATED SITE CONDITIONS, DURING CONSTRUCTION PERIOD, THESE ESC FACILITIES SHALL BE UPGRADED AS NEEDED FOR UNEXPECTED STORM EVENTS AND TO ENSURE THAT SEDIMENT AND SEDIMENT LADEN WATER DOES NOT LEAVE THE SITE.

THE ESC FACILITIES SHALL BE INSPECTED DAILY BY THE APPLICANT/CONTRACTOR AND MAINTAINED AS NECESSARY TO ENSURE THEIR CONTINUED FUNCTIONING.

7. AT NO TIME SHALL SEDIMENT BE ALLOWED TO ACCUMULATE MORE THAN $\frac{1}{2}$ THE BARRIER HEIGHT. ALL CATCH BASINS AND CONVEYANCE LINES SHALL BE CLEANED PRIOR TO PAVING. THE CLEANING OPERATIONS SHALL NOT FLUSH SEDIMENT LADEN WATER INTO THE DOWN STREAM SYSTEM.

STABILIZED GRAVEL ENTRANCES SHALL BE INSTALLED AT THE BEGINNING OF CONSTRUCTION AND MAINTAINED FOR THE DURATION OF THE PROJECT. ADDITIONAL MEASURES MY BE REQUIRED TO ENSURE THAT ALL PAVED AREAS ARE KEPT CLEAN FOR THE DURATION OF THE PROJECT.

STORM DRAINS INLETS, BASINS, AND AREA DRAINS SHALL BE PROTECTED UNTIL PAVEMENT SURFACES ARE COMPLETED AND/OR VEGETATION IS RE-ESTABLISHED. 10. PAVEMENT SURFACES AND VEGETATION ARE TO BE PLACED AS RAPIDLY AS POSSIBLE 11. SEEDING SHALL BE PERFORMED NO LATER THAN SEPTEMBER 1ST FOR EACH PHASE OF CONSTRUCTION.

12. IF THERE ARE EXPOSED SOILS OR SOILS NOT FULLY ESTABLISHED FROM OCTOBER 1^S THROUGH APRIL 30TH, THE WET WEATHER EROSION PREVENTION MEASURES WILL BE IN EFFECT. SEE THE EROSION PREVENTION AND SEDIMENT CONTROL PLANNING AND DESIGN MANUAL (CHAPTER 4) FOR REQUIREMENTS.

13. THE DEVELOPER SHALL REMOVE ESC MEASURES WHEN VEGETATION IS FULLY ESTABLISHED.

PERMITTEE'S SITE INSPECTOR:

COMPANY/AGENCY: PHONE: CELL: E-MAIL:

DESCRIPTION OF EXPERIENCE:

NARRATIVE DESCRIPTIONS

EXISTING SITE CONDITIONS UNDEVELOPED LAND WITH EXISTING NURSERY, BARN, AND SMALL ACCESSORY BUILDING.

DEVELOPED CONDITIONS

DEVELOPMENT OF RESIDENTIAL SUBDIVISION INCLUDING THE CONSTRUCTION OF PRIVATE ROADS AND UNDERGROUND UTILITIES NECESSARY TO SERVE 20 NEW SINGLE-FAMILY HOMES.

NATURE OF CONSTRUCTION ACTIVITY AND ESTIMATED TIME TABLE

CLEARING - ##### MASS GRADING - #### SITE CONSTRUCTION - #### FINAL STABILIZATION - ####

TOTAL SITE AREA = 3.11 ACRES

TOTAL DISTURBED AREA = 3.11 ACRES

SITE SOIL CLASSIFICATION


12A - CANDERLY SANDY LOAM (NRCS HYDROLIC SOIL GROUP A)

NEAREST WATER BODY: EXISTING ON-SITE DETENTION POND THAT ULTIMATELY DISCHARGES TO BEAR CREEK TO THE EAST


SHEET INDEX

SHEET NUMBER	SHEET TITLE
050	COVER SHEET
051	DEMO AND PHASE I ESCP
052	PHASE II ESCP
053	ESCP DETAILS
054	ESCP DETAILS

1200C COVER SHEET 00% CONSTRUCTION PLAN SET 00% CONSTRUCTION PLAN SET 00
Know what's below. Call before you dig. REVISIONS:
Call before you dig. REVISIONS:
CREGON CREGON
OREGON OREGON OREGON OREGON DEL 259 DEL 20002753 FILE NO. ## DATE 5/10/2021 SHEET NO.
OREGON OREGON OREGON OREGON DEL 259 DEL 20002753 FILE NO. ## DATE 5/10/2021 SHEET NO.
OREGON OREGON OREGON OREGON DEL 259 DEL 20002753 FILE NO. ## DATE 5/10/2021 SHEET NO.
DR. J. ZHANG DR. J. ZHANG JOB NO. 20002753 FILE NO. ## DATE 5/10/2021 SHEET NO.
PM. B. BERRY DR. J. ZHANG JOB NO. 20002753 FILE NO. ## DATE 5/10/2021 SHEET NO.
DR. J. ZHANG JOB NO. 20002753 FILE NO. ## DATE 5/10/2021 SHEET NO.
20002753 FILE NO. ## DATE 5/10/2021 SHEET NO.
DATE 5/10/2021 SHEET NO.
5/10/2021 SHEET NO.

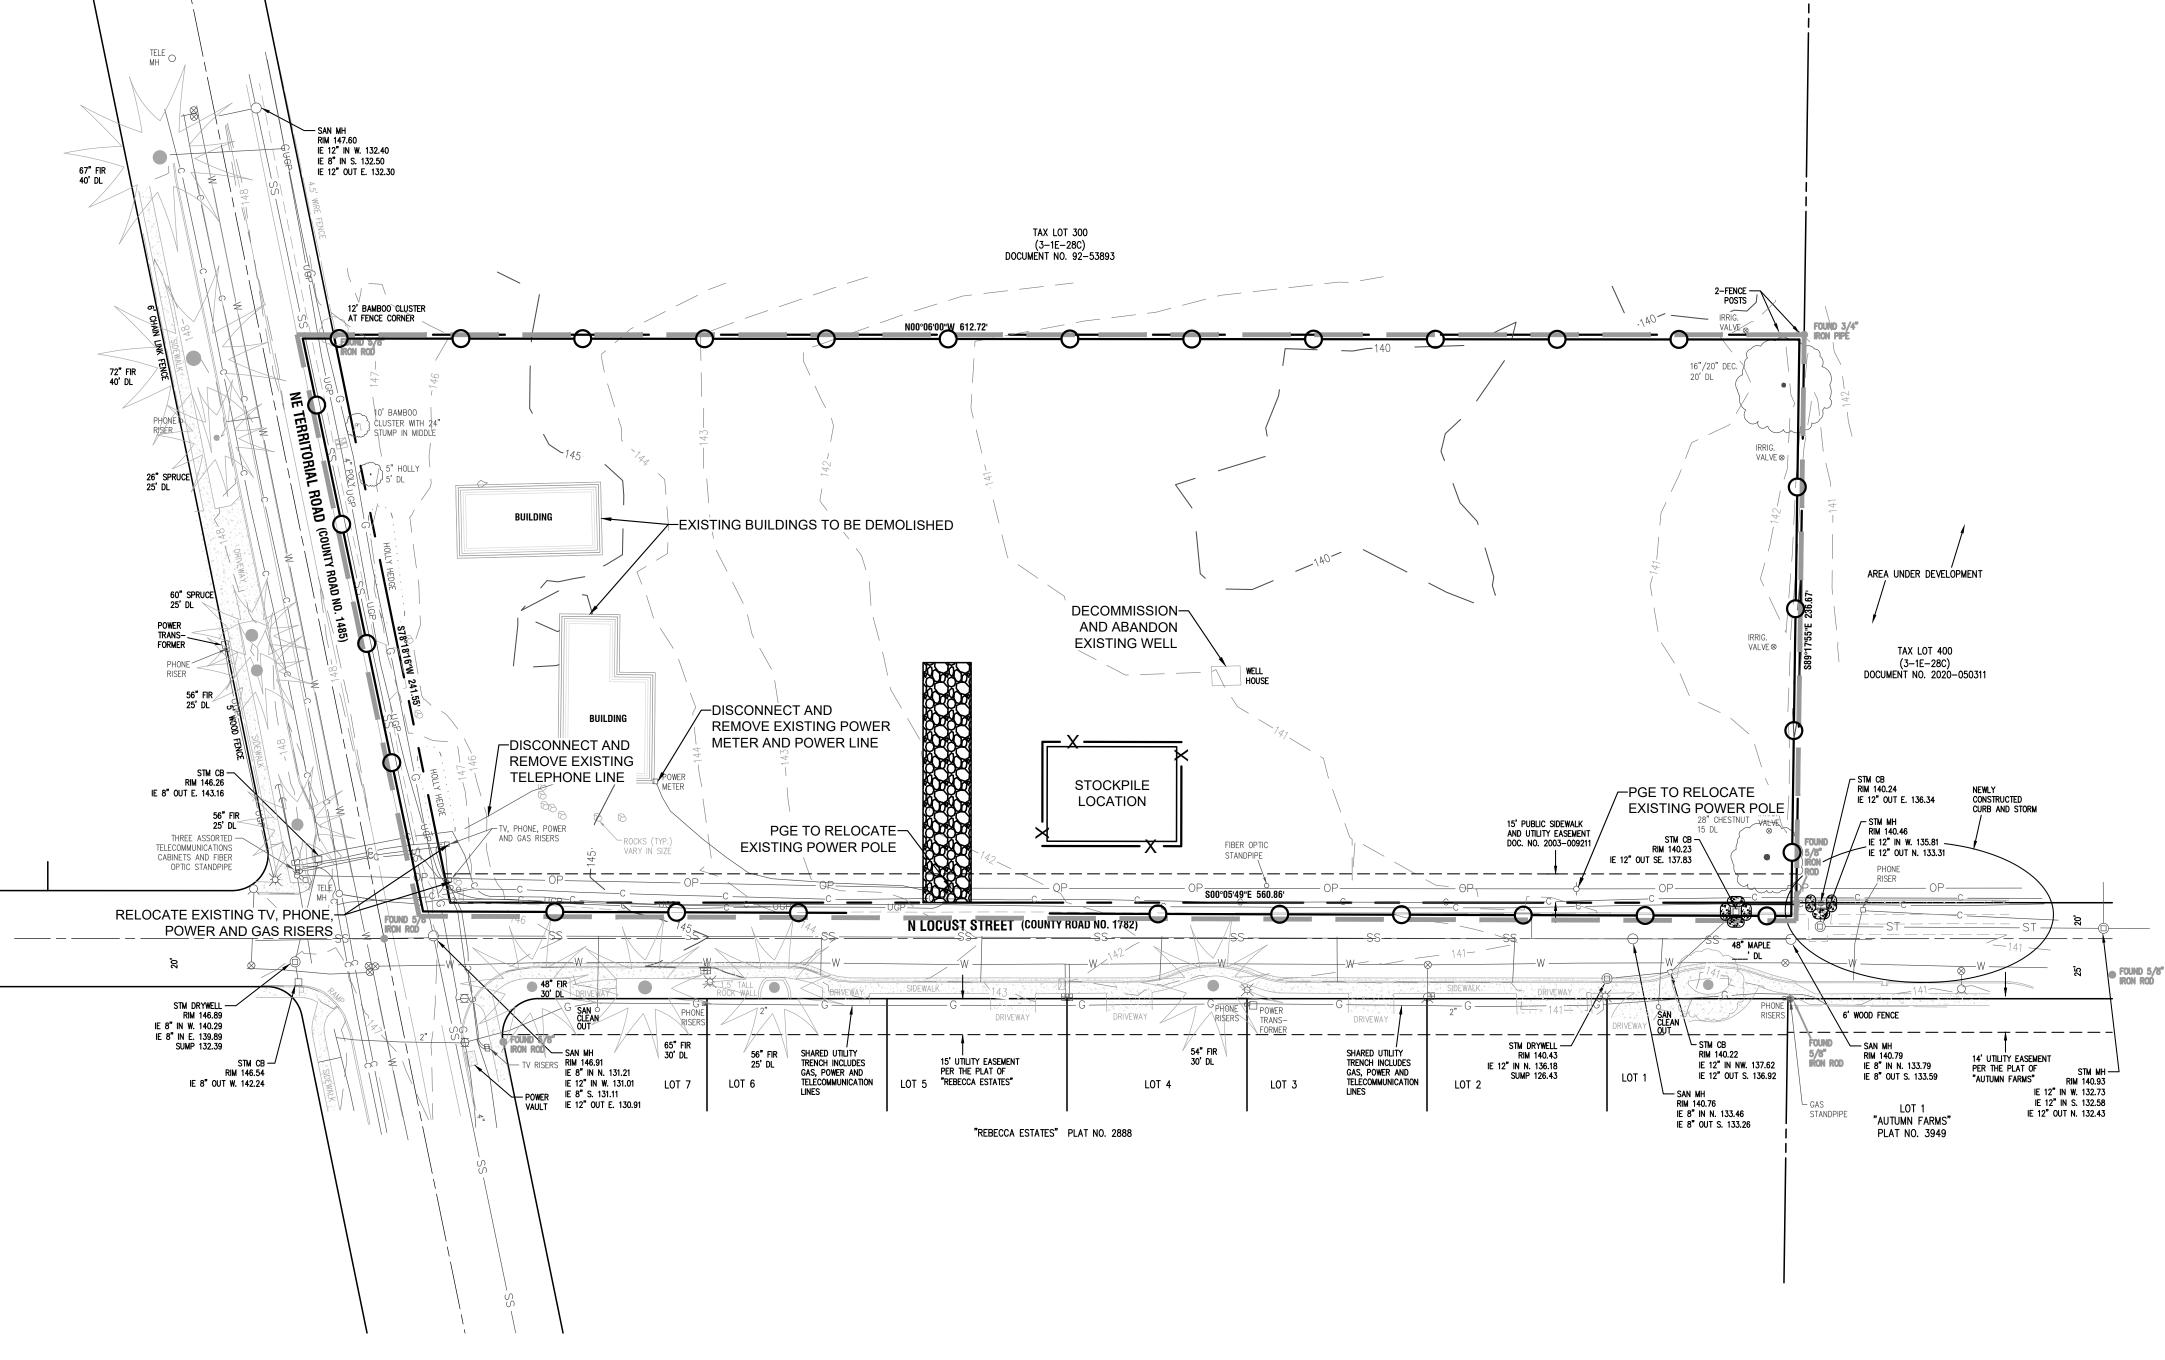



<u>LEGEND</u>

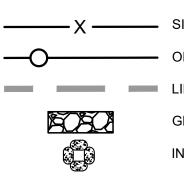


SILT FENCE ORANGE CONSTRUCTION FENCE LIMITS OF DISTURBANCE GRAVEL CONSTRUCTION ENTRANCE INLET PROTECTION

THE LOCATIONS OF EXISTING THE LOCATIONS OF EXISTING UNDERGROUND UTILITIES ARE SHOWN IN AN APPROXIMATE WAY ONLY AND HAVE NOT BEEN INDEPENDENTLY VERIFIED BY THE OWNER OR ITS REPRESENTATIVE. THE CONTRACTOR SHALL DETERMINE THE EXACT LOCATION OF ALL EXISTING UTILITIES BEFORE COMMENCING WORK, AND AGREES TO BE FULLY RESPONSIBLE EOR ANY AND ALL DAMAGES WHICH FOR ANY AND ALL DAMAGES WHICH MIGHT BE OCCASIONED BY THE CONTRACTOR'S FAILURE TO EXACTLY LOCATE AND PRESERVE ANY AND ALL UNDERGROUND UTILITIES. NOTICE: NOTICE: CONSTRUCTION SITE SAFETY IS THE SOLE RESPONSIBILITY OF THE <u>CONTRACTOR</u>; NEITHER THE OWNER NOR THE ENGINEER SHALL BE EXPECTED TO ASSUME ANY RESPONSIBILITY FOR SAFETY OF THE WORK, OF PERSONS ENGAGED IN THE WORK, OF ANY NEARBY STRUCTURES, OR OF ANY OTHER PERSONS. 90% CONSTRUCTION PLAN SET RRITORIAL ROAD SUBDIVISION ESCP $\overline{}$ PHASE DEMO AND Ξ **81** Know what's below. Call before you dig. **REVISIONS**: EXP.12/31/21 PM. B. BERRY DR. J. ZHANG JOB NO. 20002753 FILE NO. 20002753 DATE 5/10/2021 SHEET NO. C051

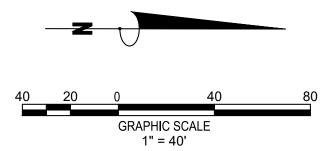

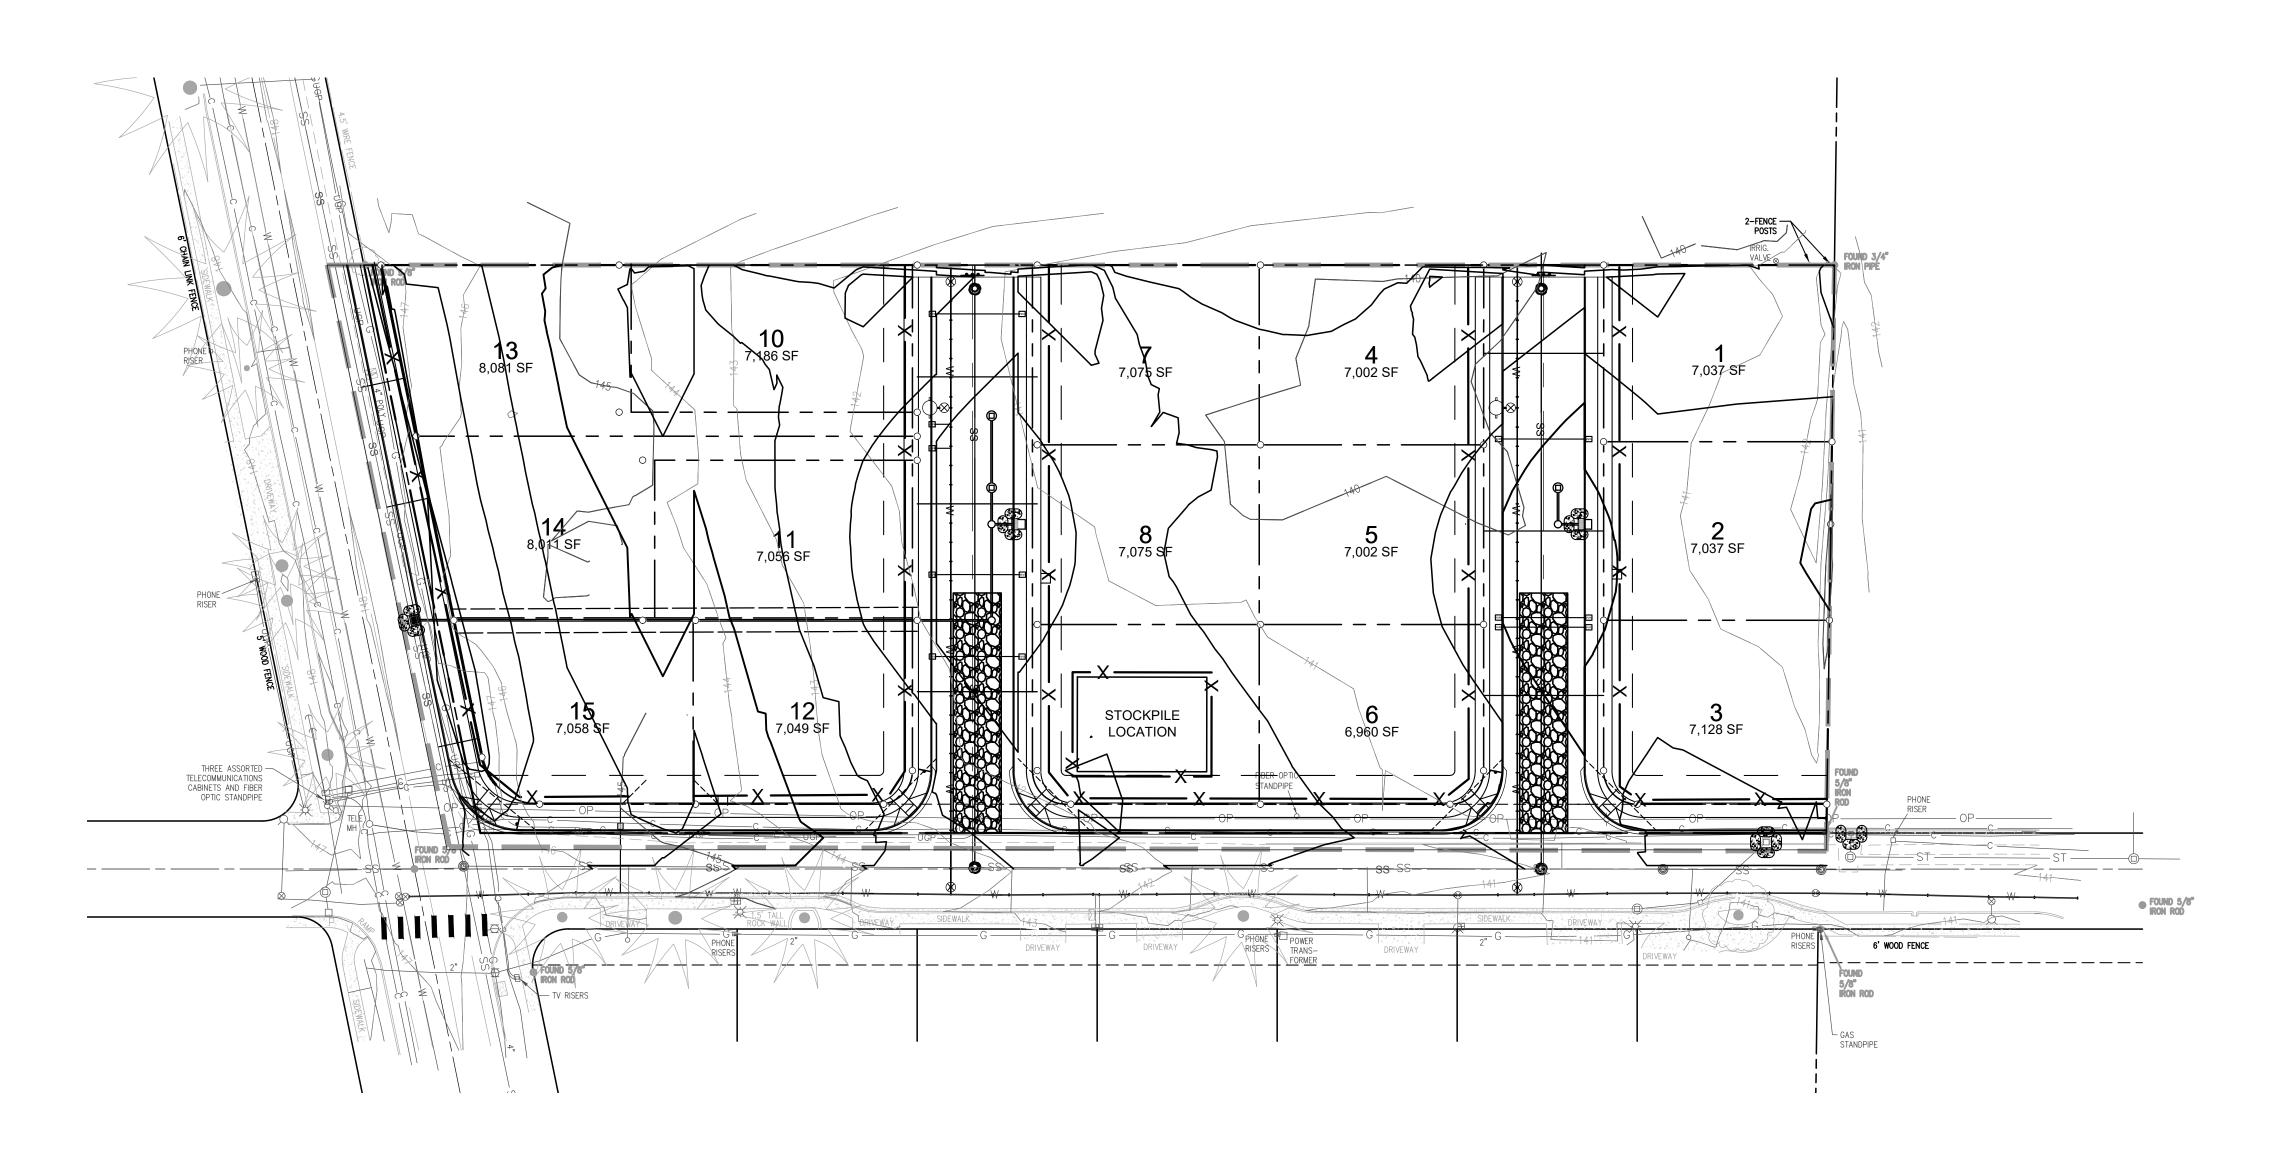

LEGEND

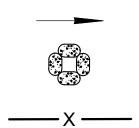



DIRECTION OF POST-DEVELOPED RUNOFF

INLET PROTECTION

SILT FENCE

R L L C L C L C C R R N	THE LOCATIONS OF EXISTING UNDERGROUND UTILITIES ARE SHOWN IN AN APPROXIMATE WAY ONLY AND HAVE NOT BEEN INDEPENDENTLY VERIFIED BY THE OWNER OR ITS REPRESENTATIVE. THE CONTRACTOR SHALL DETERMINE THE EXACT LOCATION OF ALL EXISTING UTILITIES BEFORE COMMENCING WORK, AND AGREES TO BE FULLY RESPONSIBLE FOR ANY AND ALL DAMAGES WHICH MIGHT BE OCCASIONED BY THE CONTRACTOR'S FAILURE TO EXACTLY LOCATE AND PRESERVE ANY AND ALL UNDERGROUND UTILITIES. NOTICE: CONSTRUCTION SITE SAFETY IS THE SOLE RESPONSIBILITY OF THE CONTRACTOR'S NEITHER THE OWNER NOR THE ENGINEER SHALL BE EXPECTED TO ASSUME ANY RESPONSIBILITY FOR SAFETY OF THE WORK, OF PERSONS ENGAGED IN THE WORK, OF ANY NEARBY STRUCTURES, OR OF ANY OTHER PERSONS.			
		866.850.4200 www.atwell 9755 SW. BARNES ROAD, SUI PORTLAND, OR 97225 971.334.8960		
	PHASE 2 ESCP	90% CONSTRUCTION PLAN SET TERRITORIAL ROAD SUBDIVISION CANBY, OREGON		
		at's below.		
	RE	/ISIONS:		
	EXP.1	PROFESS GINEEP 4,919 RECOMPROTON 25, 199 L. BERRY 2/31/21 BERRY ZHANG		
	JC 20 FI 20 [5/1	ZHANG DB NO. 002753 LE NO. 002753 DATE 10/2021		
		ет NO. 052		

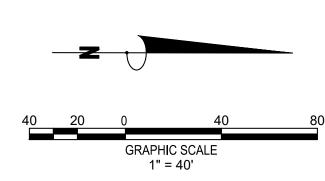

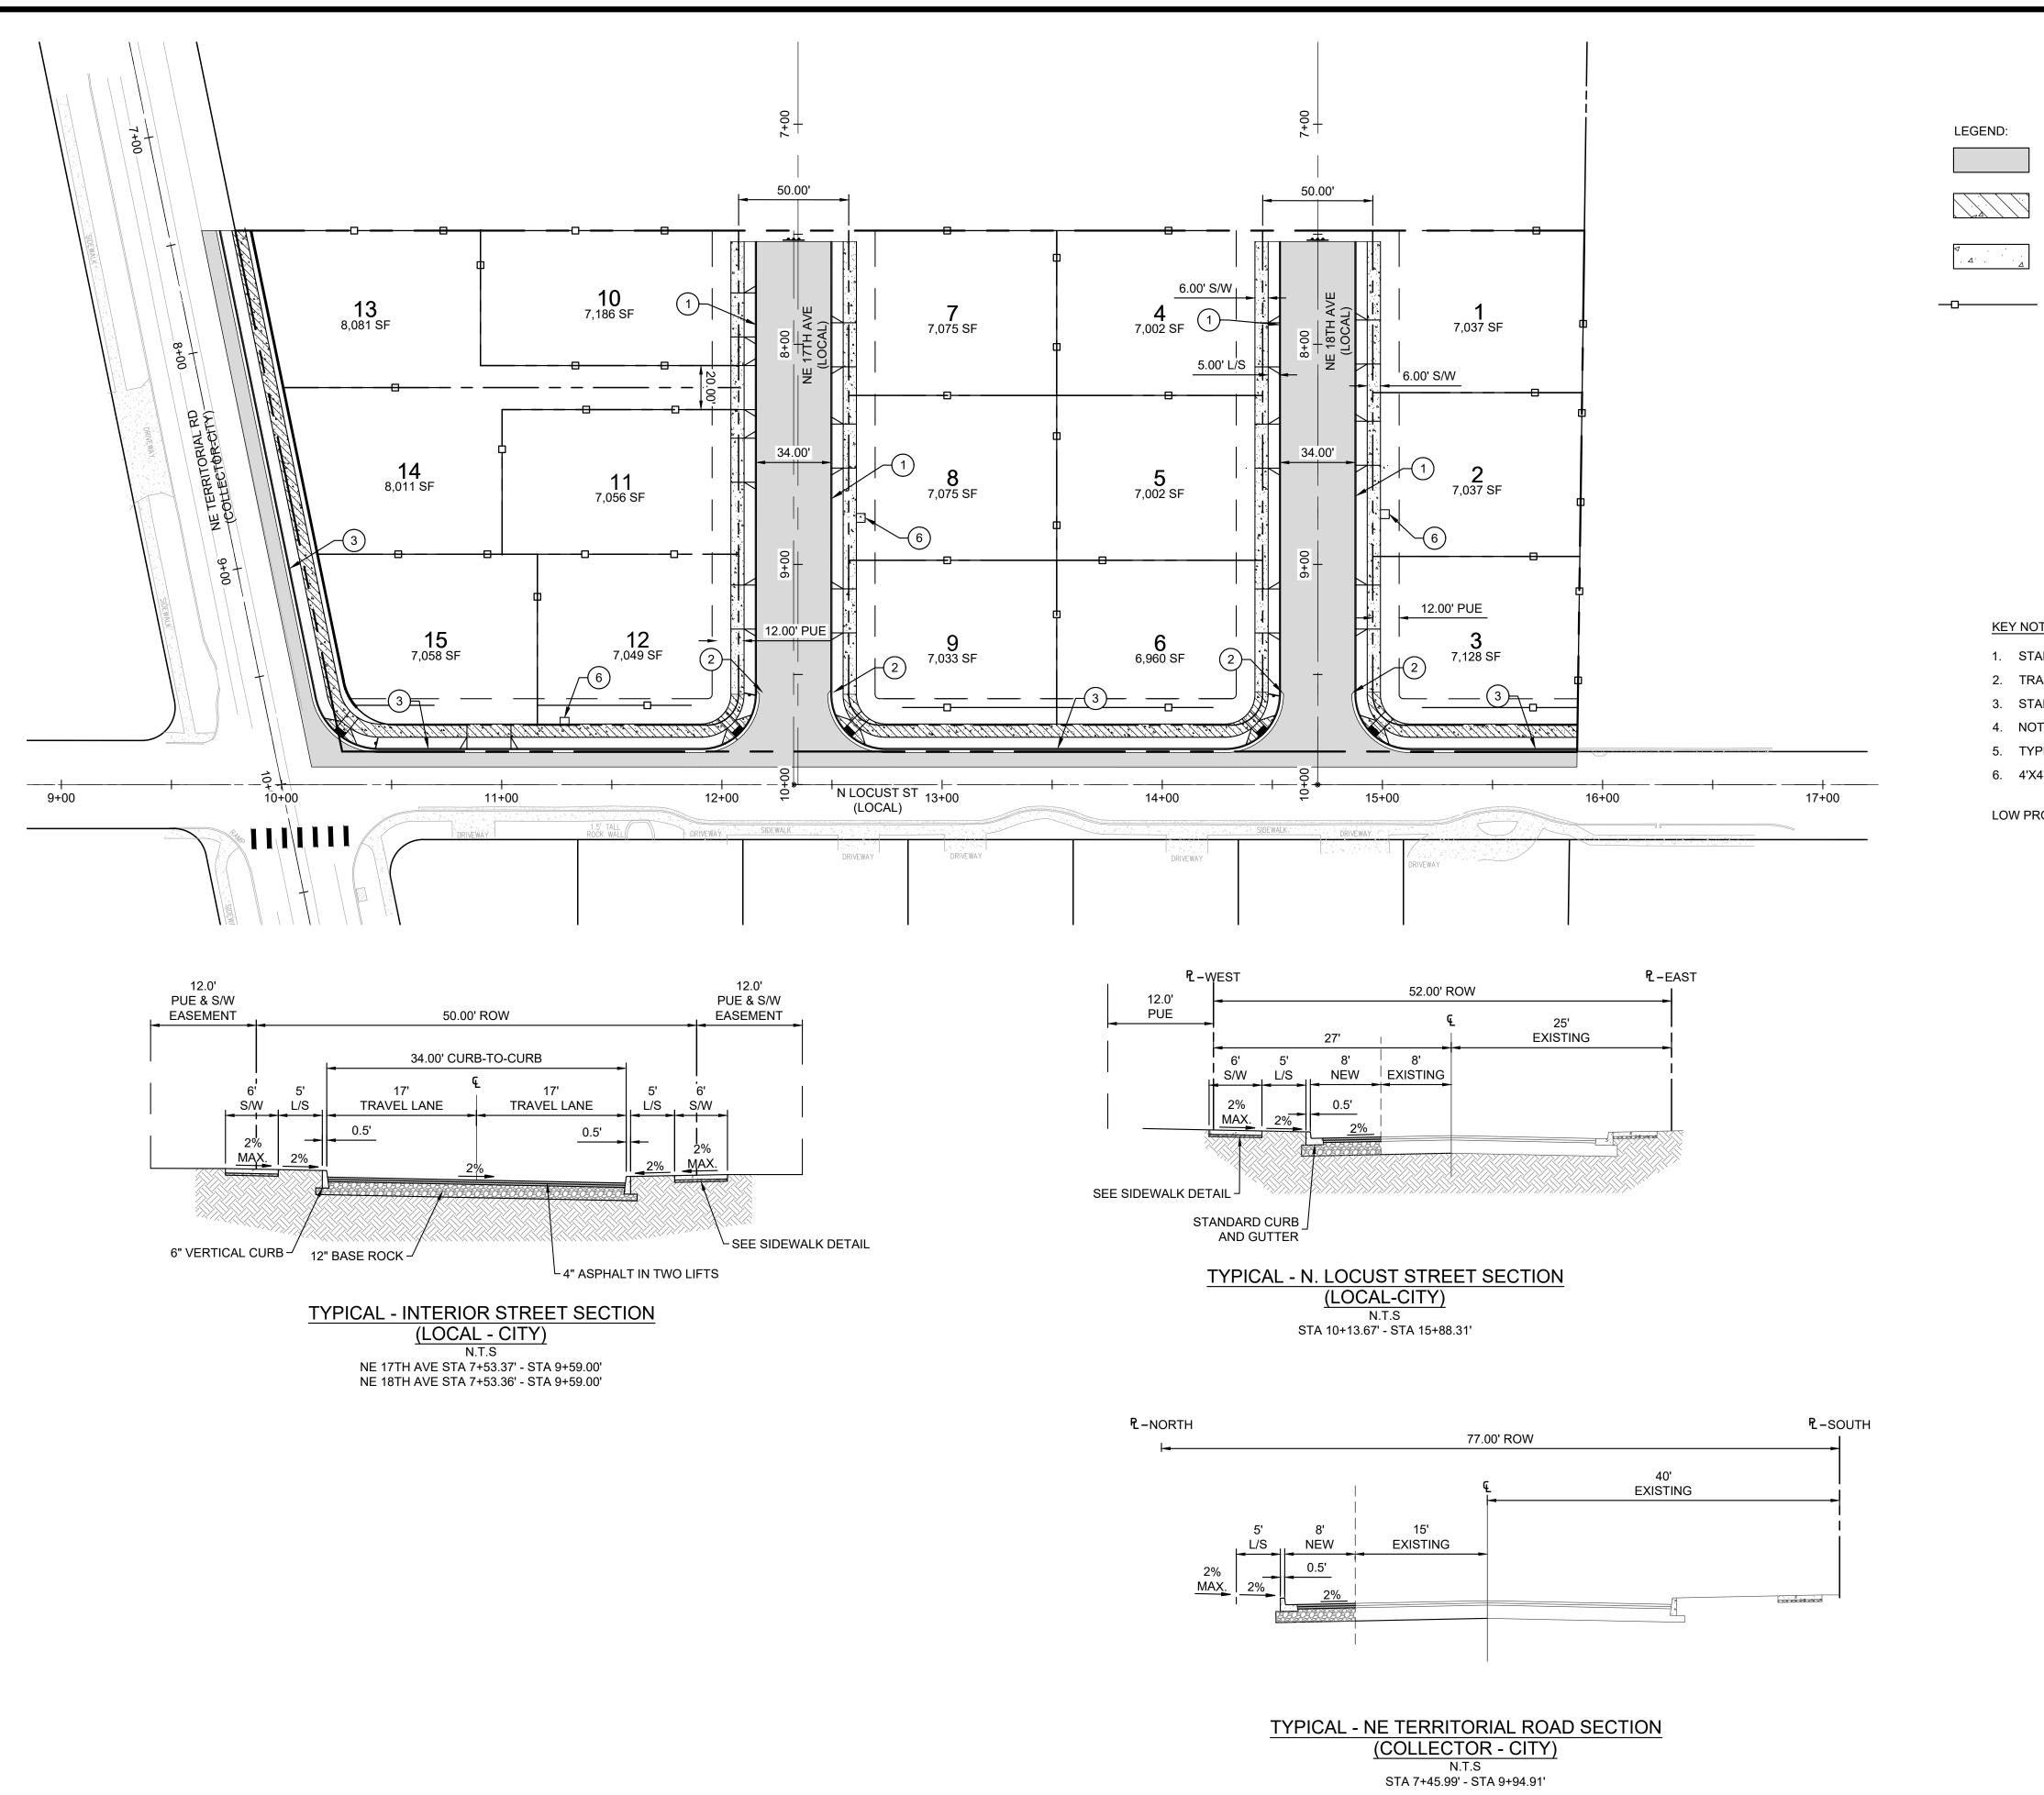

):	
	ASPHALT
	CONCRETE S WORK
Δ	CONCRETE S HOME CONST

SIDEWALK TO BE CONSTRUCTED WITH SITE

SIDEWALK TO BE CONSTRUCTED AT TIME OF TRUCTION


6' GOOD NEIGHBOR STYLE WOOD FENCE TO BE CONSTRUCTED AT TIME OF HOME CONSTRUCTION

L/S = LANDSCAPE STRIP S/W = SIDEWALK

KEY NOTES (#):


- 1. STANDARD VERTICAL CURB
- 2. TRANSITION BETWEEN GUTTER TO NO GUTTER
- 3. STANDARD CURB AND GUTTER
- 4. NOT USED
- 5. TYPE A CURB RAMP (SEE)
- 6. 4'X4' CONCRETE PAD FOR MAILBOX


LOW PROFILE MOUNTABLE CURB

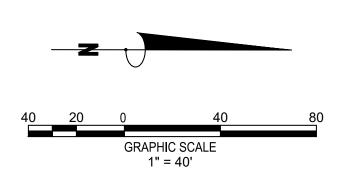



UNDERGROUND IN AN APPROXI HAVE NOT BEI VERIFIED BY REPRESENTATI SHALL DETE LOCATION OF A BEFORE COM AGREES TO BE FOR ANY AND J MIGHT BE OU CONTRACTOR'S LOCATE AND PF UNDERGR N CONSTRUCTION SOLE RESPO <u>CONTRACTOR'S</u> NOR THE EN EXPECTED RESPONSIBILITY WORK, OF PERS WORK, OF PERS	IONS OF EXISTING UTILITIES ARE SHOWN MATE WAY ONLY AND EN INDEPENDENTLY THE OWNER OR ITS /E. THE CONTRACTOR RMINE THE EXACT LL EXISTING UTILITIES MENCING WORK, AND FULLY RESPONSIBLE ALL DAMAGES WHICH CCASIONED BY THE FAILURE TO EXACTLY RESERVE ANY AND ALL OUND UTILITIES. OTICE: N SITE SAFETY IS THE DNSIBILITY OF THE NEITHER THE OWNER GINEER SHALL BE TO ASSUME ANY Y FOR SAFETY OF THE ONS ENGAGED IN THE NEARBY STRUCTURES, OTHER PERSONS.			
	866.850.4200 www.atwell-group.com 9755 SW. BARNES ROAD, SUITE150 971.334.8960			
SITE PLAN AND STREET SECTIONS	90% CONSTRUCTION PLAN SET TERRITORIAL ROAD SUBDIVISION CANBY, OREGON			
Call b	Know what's below. Call before you dig.			
	REVISIONS:			
OREGOINES NG INESP 14,919 OREGOINES NDY L. BERT EXP.12/31/21 PM. B. BERRY				
DR. J. 2 JC 200 FII 2000 E 5/1	DR. J. ZHANG JOB NO. 20002753 FILE NO. 20002753-SP DATE 5/10/2021			
	SHEET NO. C100			




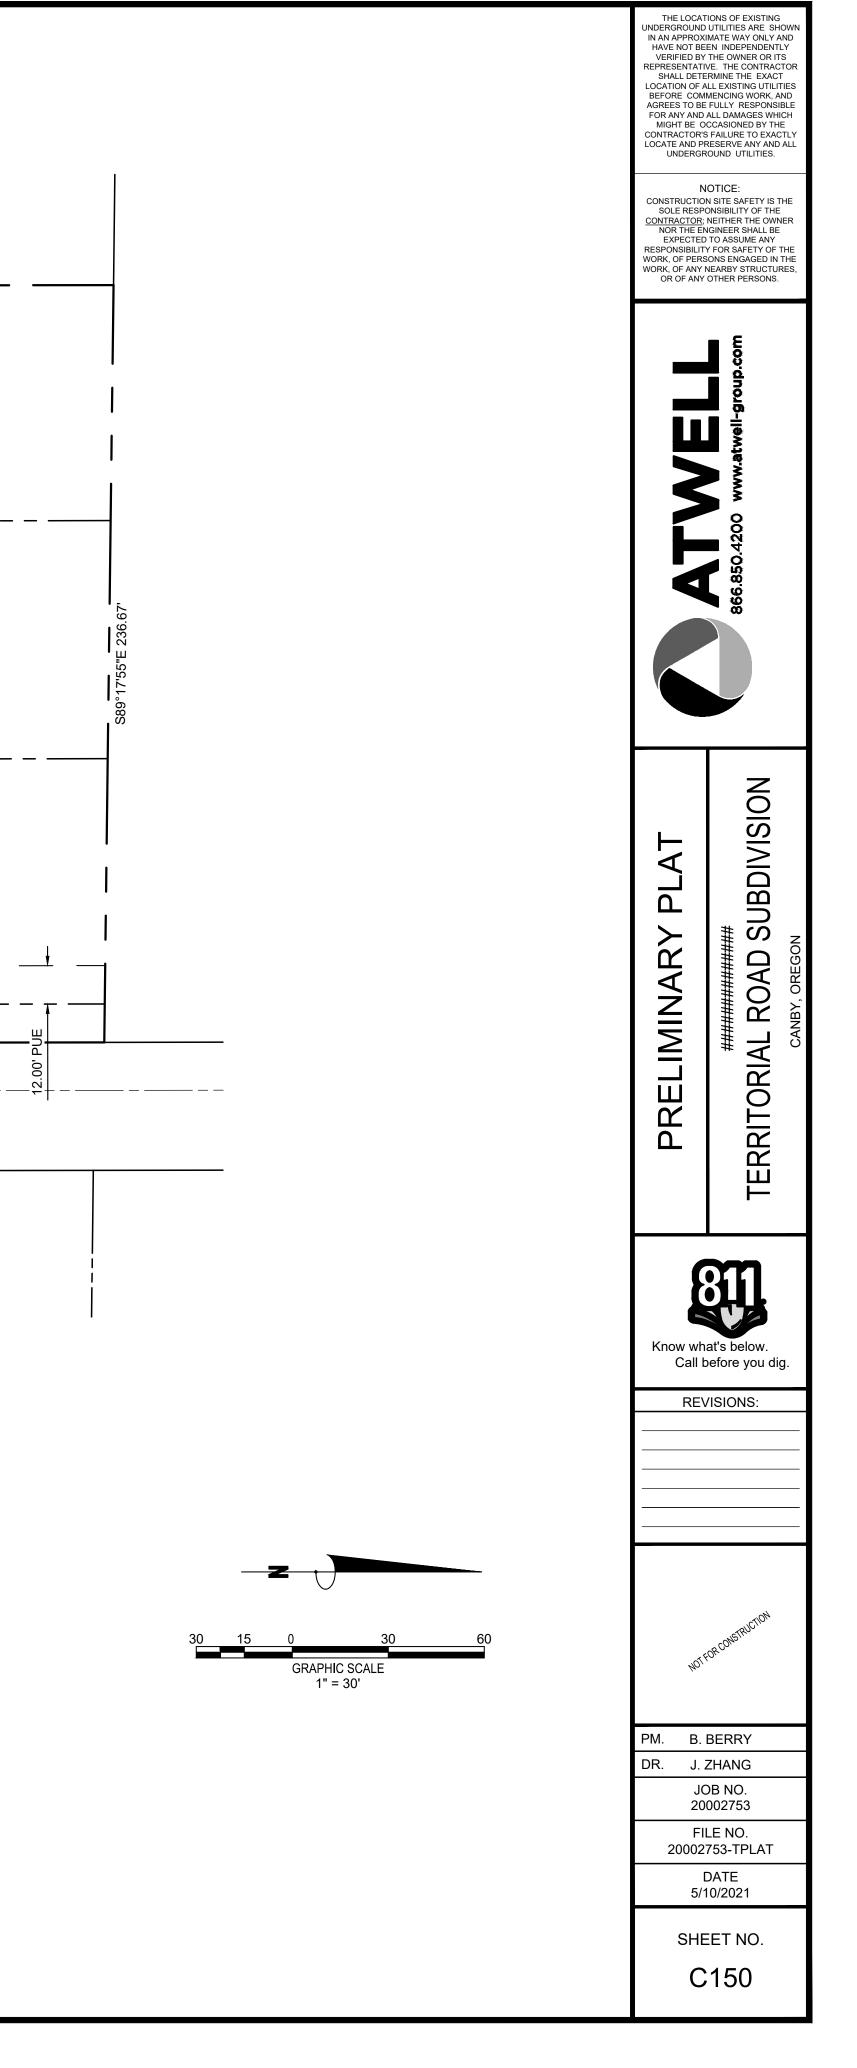


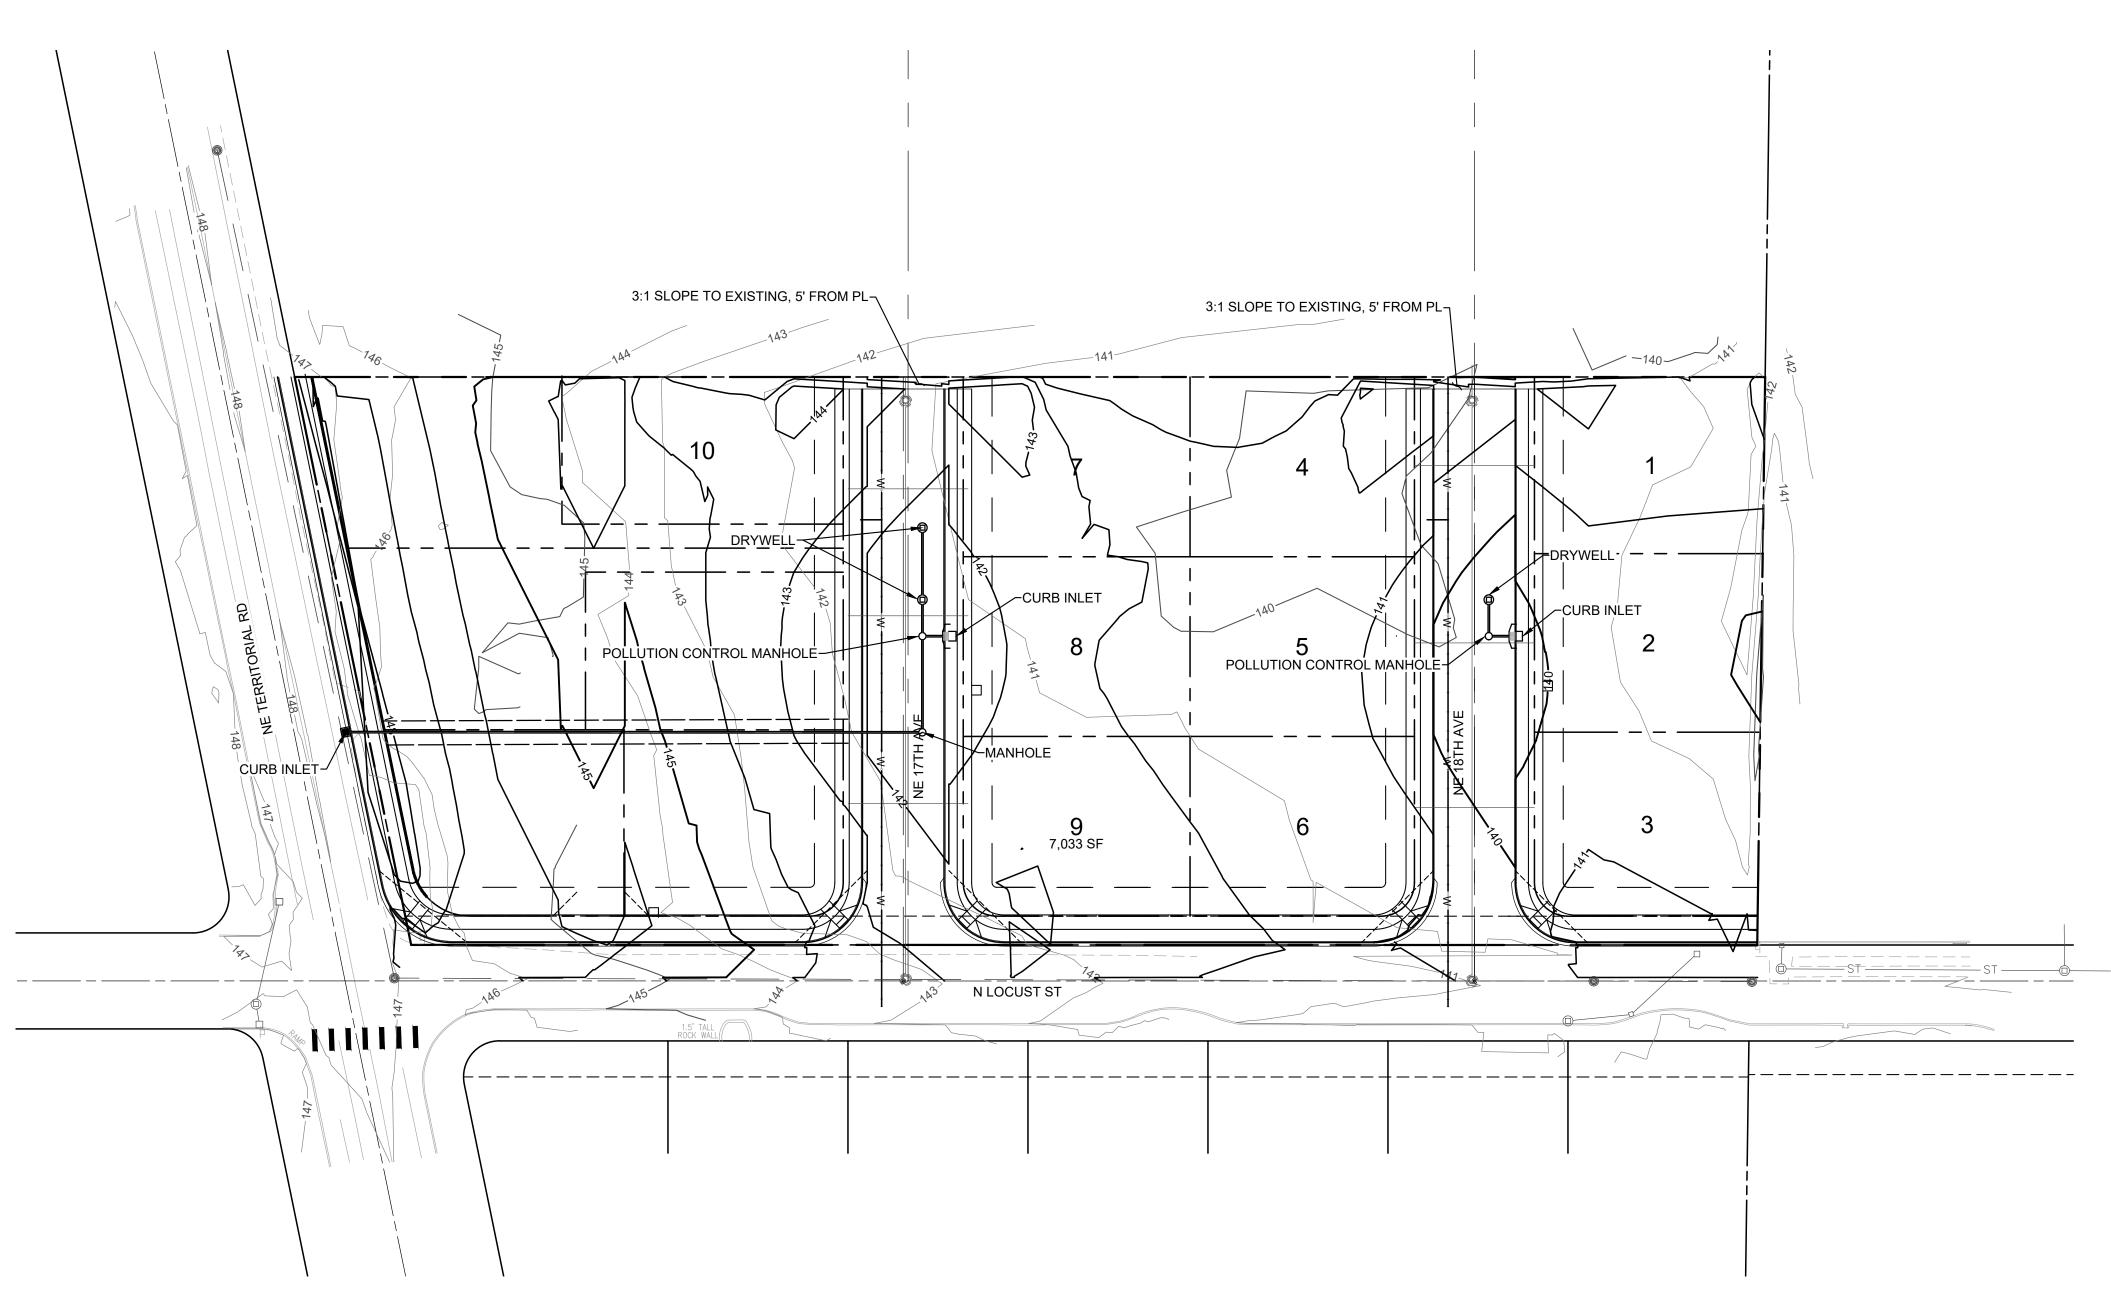


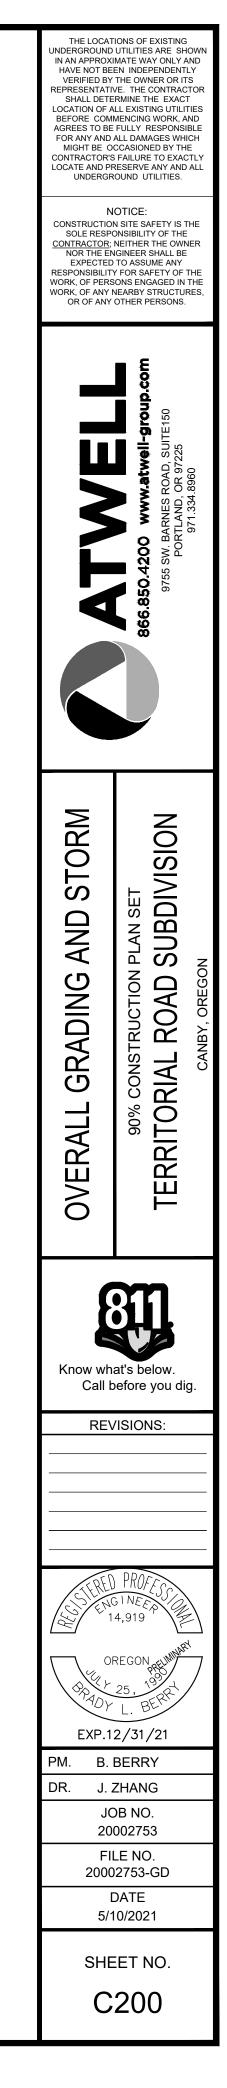

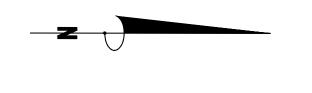


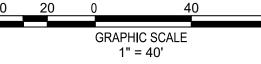

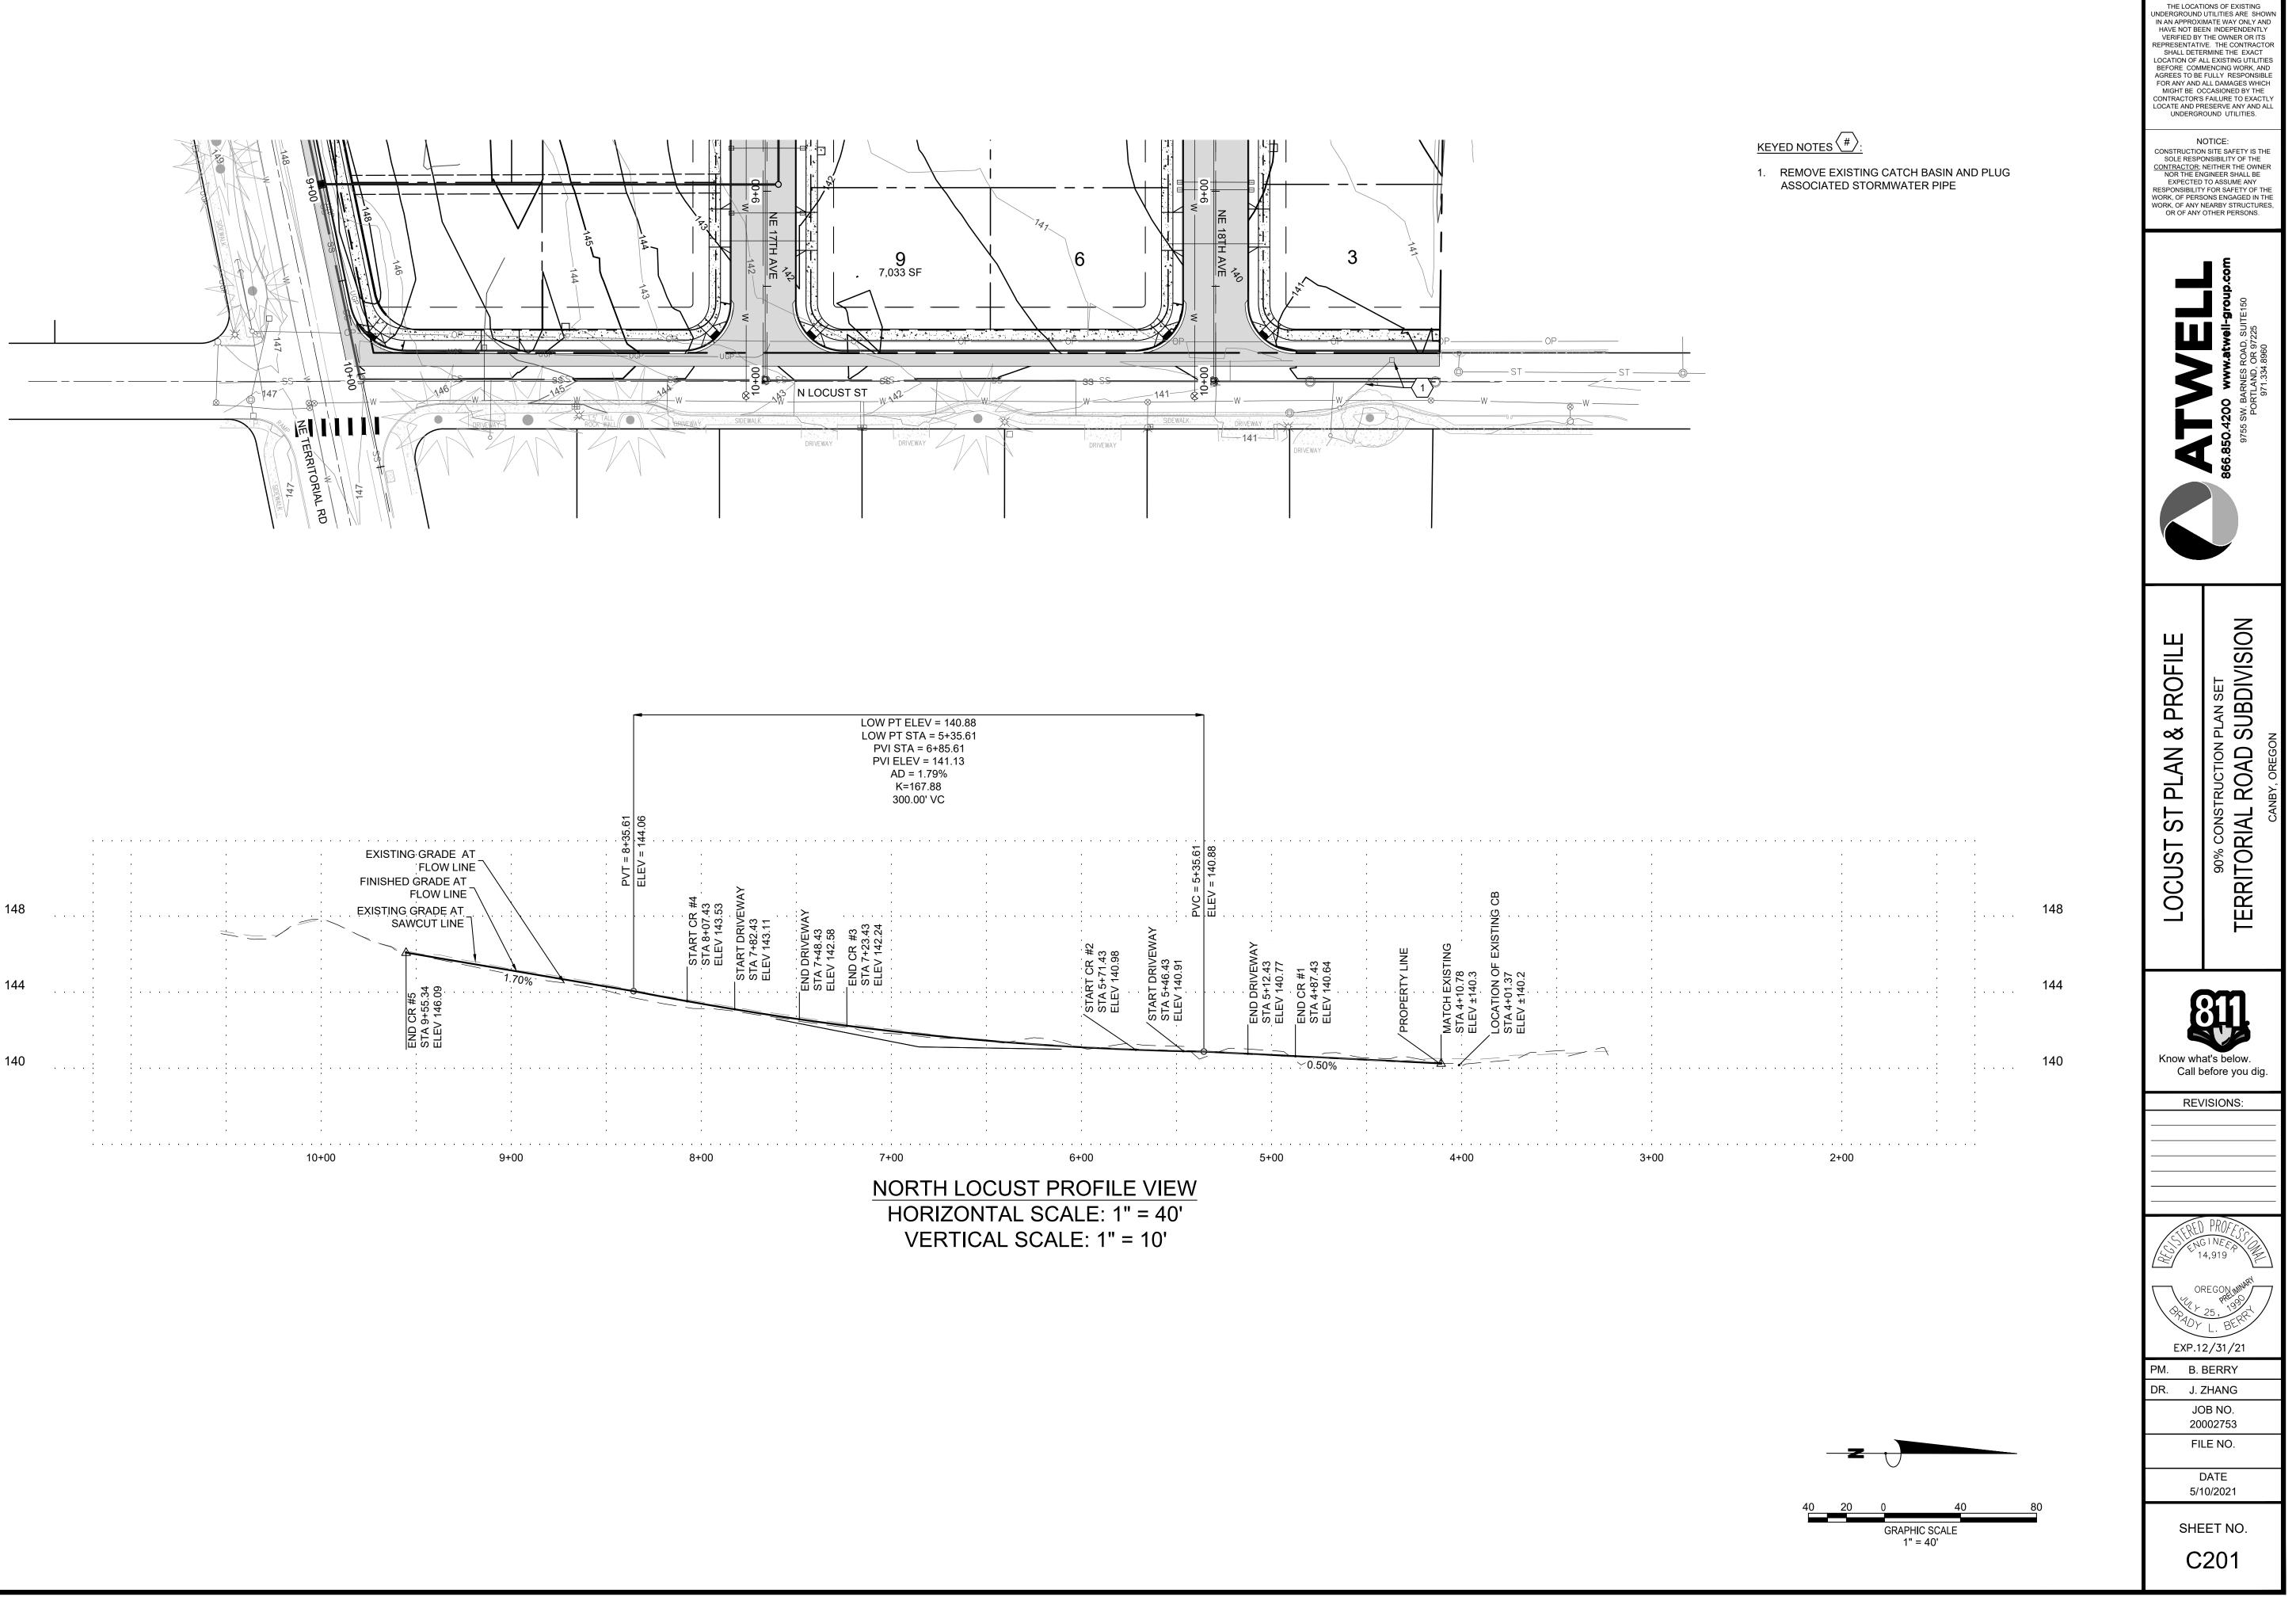

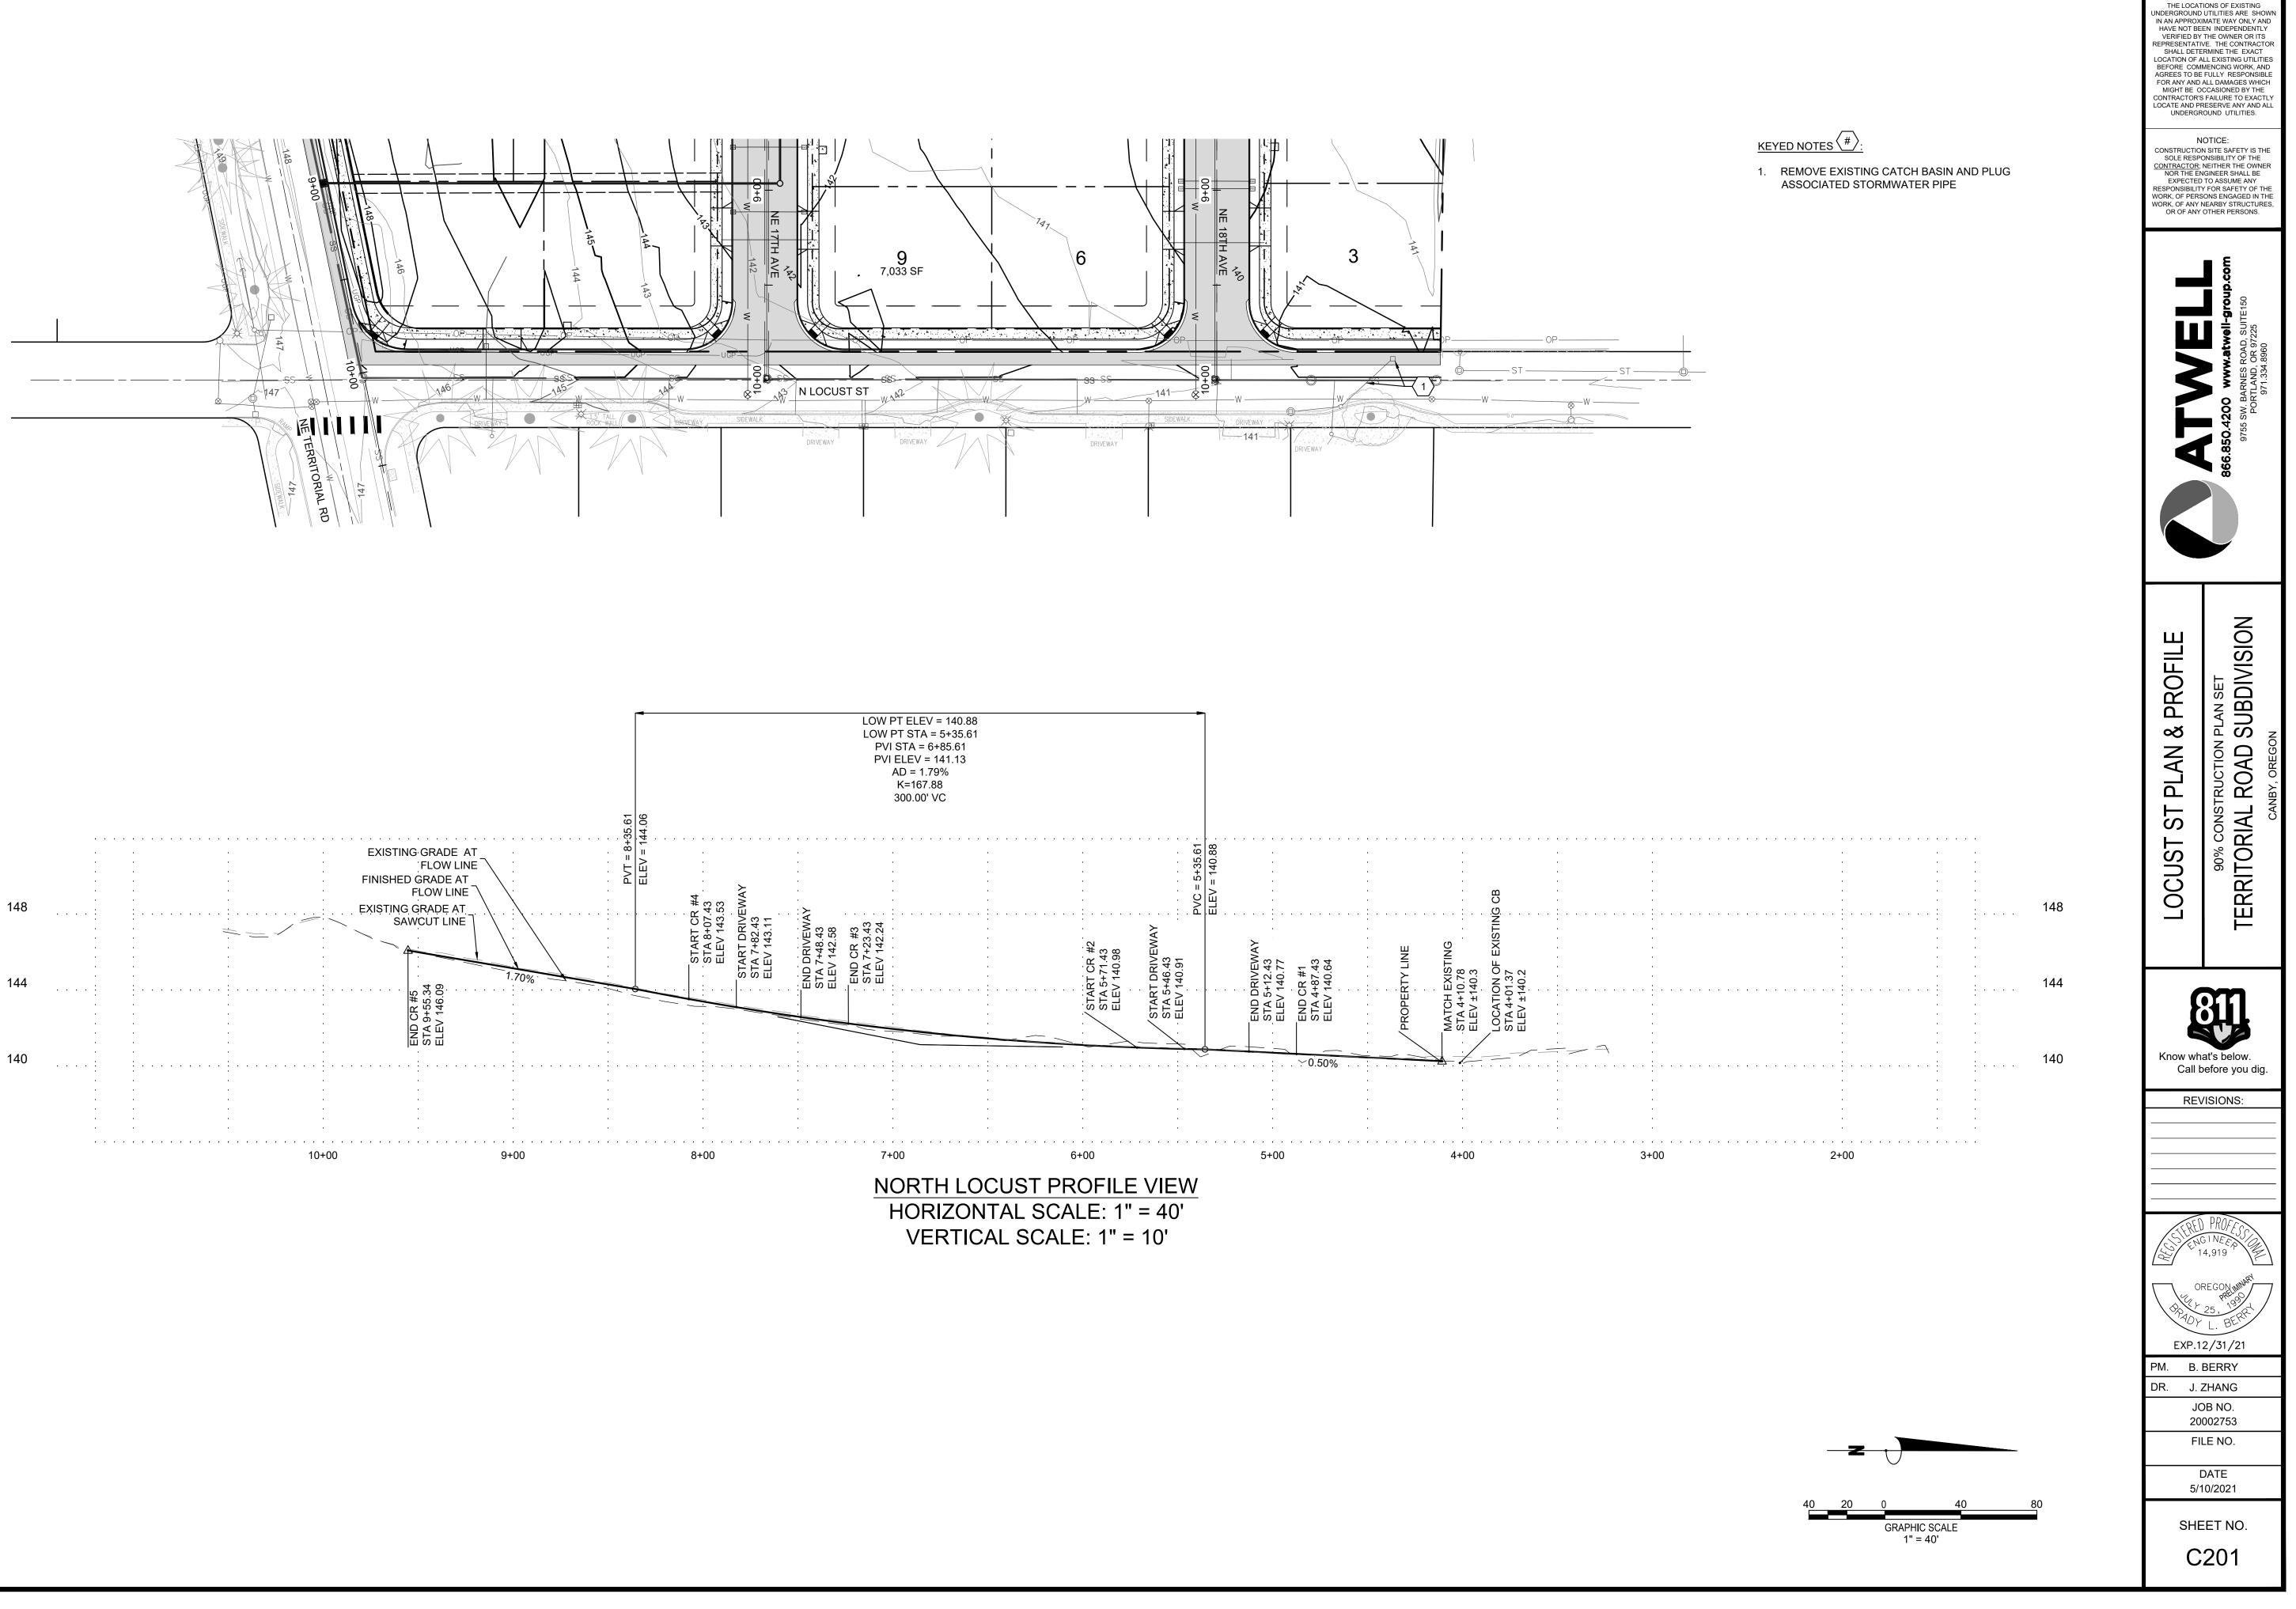





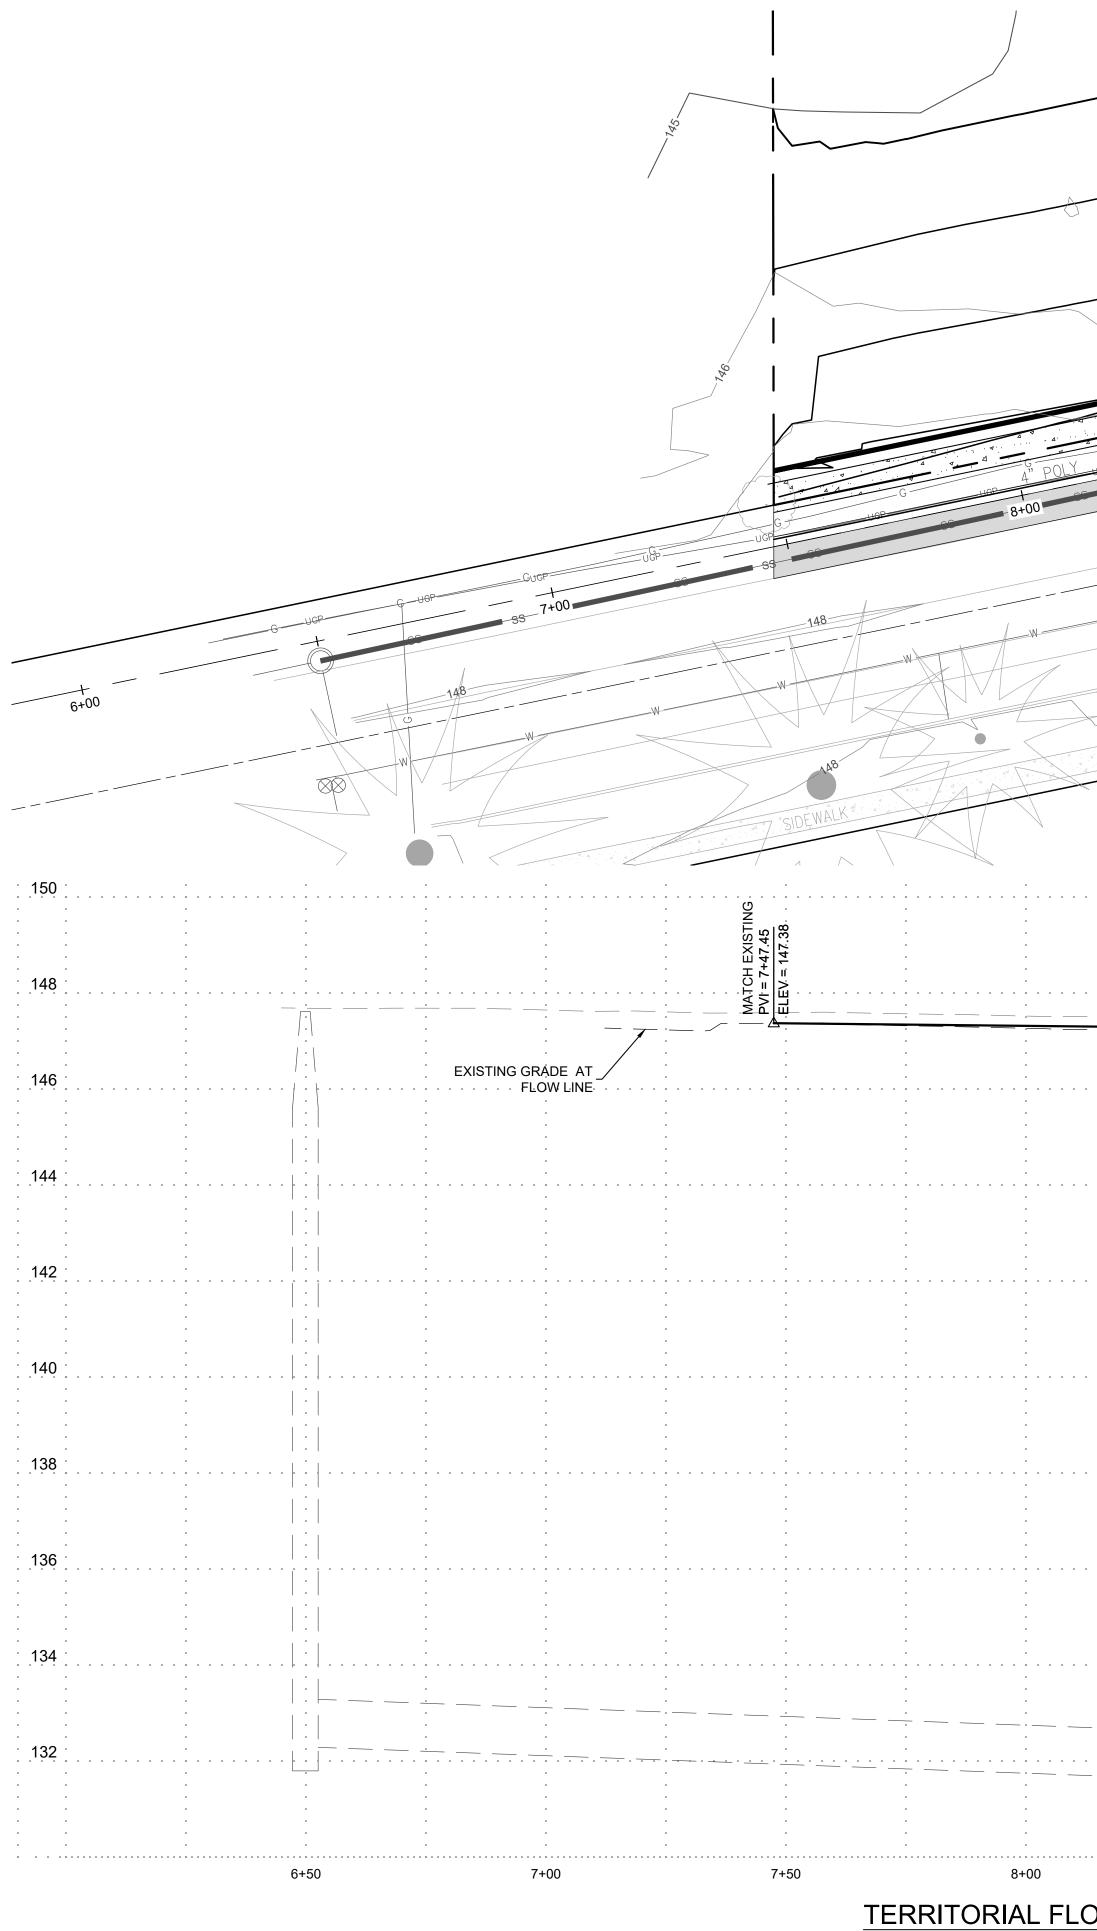


HORIZONTAL SCALE: 1" = 20' VERTICAL SCALE: 1" = 10'


		146			
	4 G G UCP G G G G G G G G G G G G G G G G G G G			+00 ⁷	
W W WAY		SIĎEWALK GP		-	dat dat
<u>-0.11%</u> <u></u>	PVI = 8+94.21 ELEV = 147.22	0.09%	PVI = 9+63.50 ELEV = 147.29		150 148
FINISHED GRADE AT FLOW LINE EXISTING GRADE AT SAWCUT LINE					146
		1 1			
· · · · · · · · · · · · · · · · · · ·	1 .	1 1			138 136
-OW LINE PROFILE VIEV	9+00 <u>V</u>	9+50		10+00	

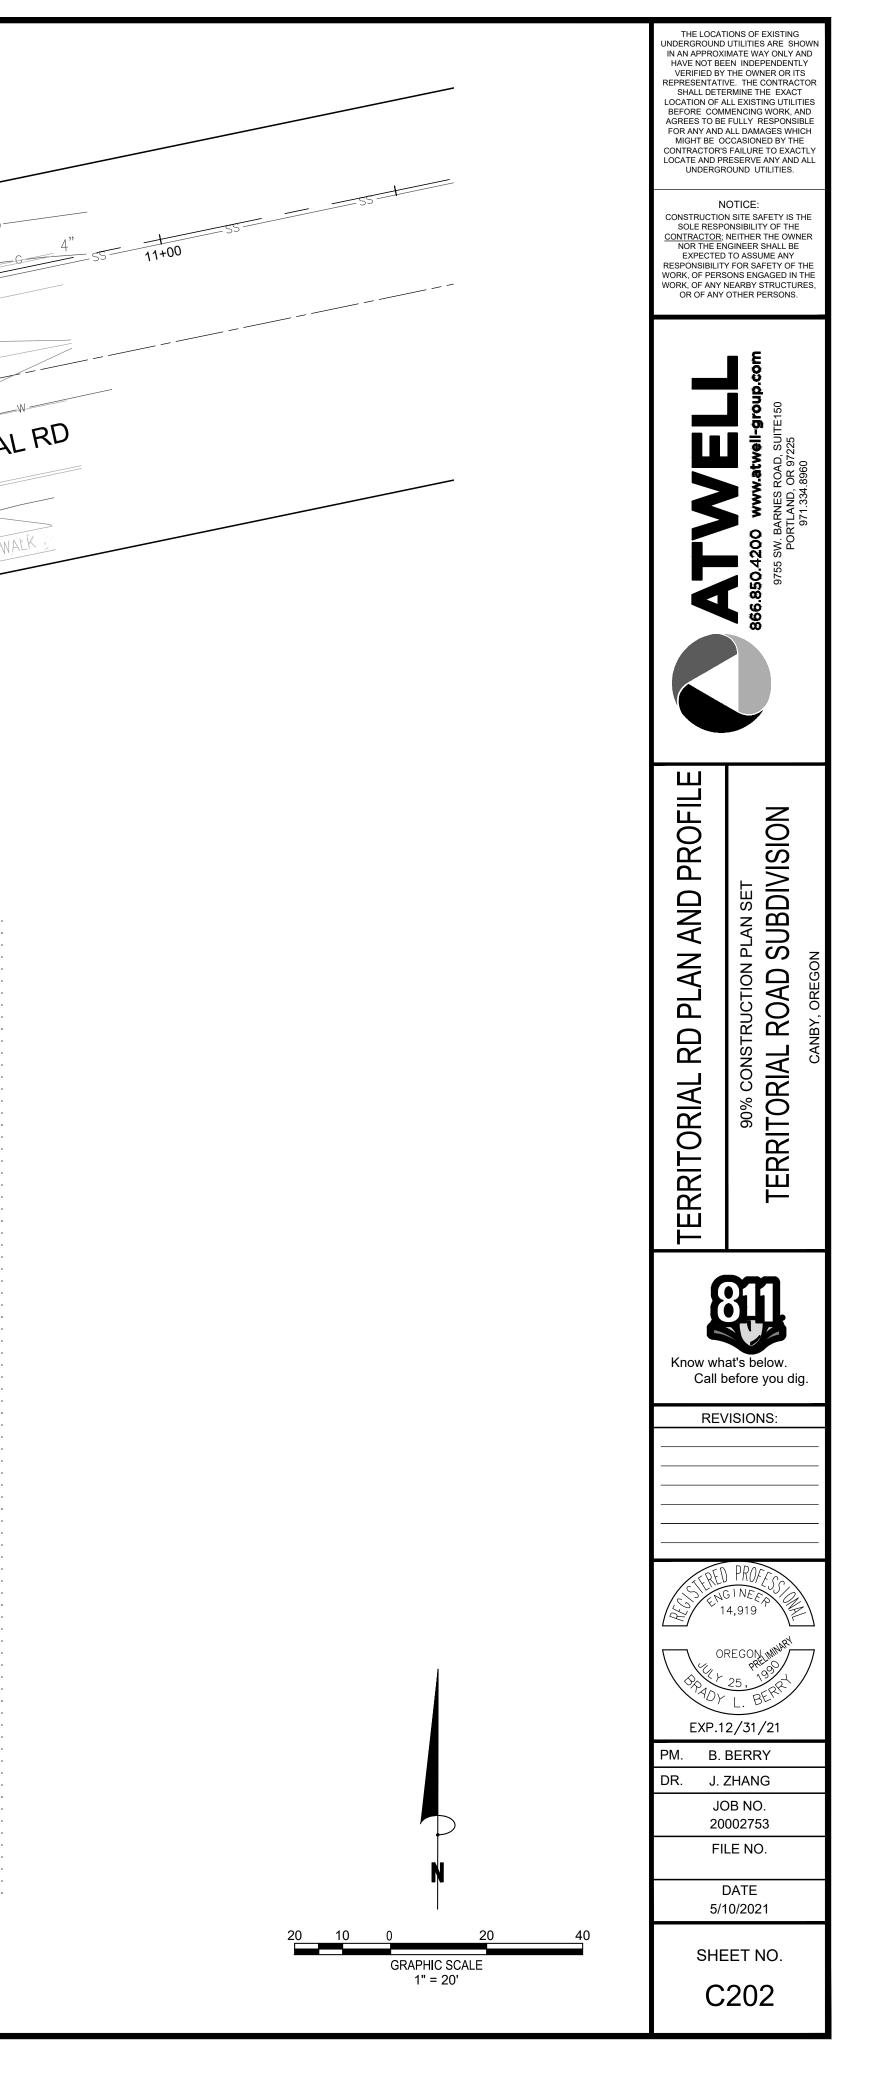


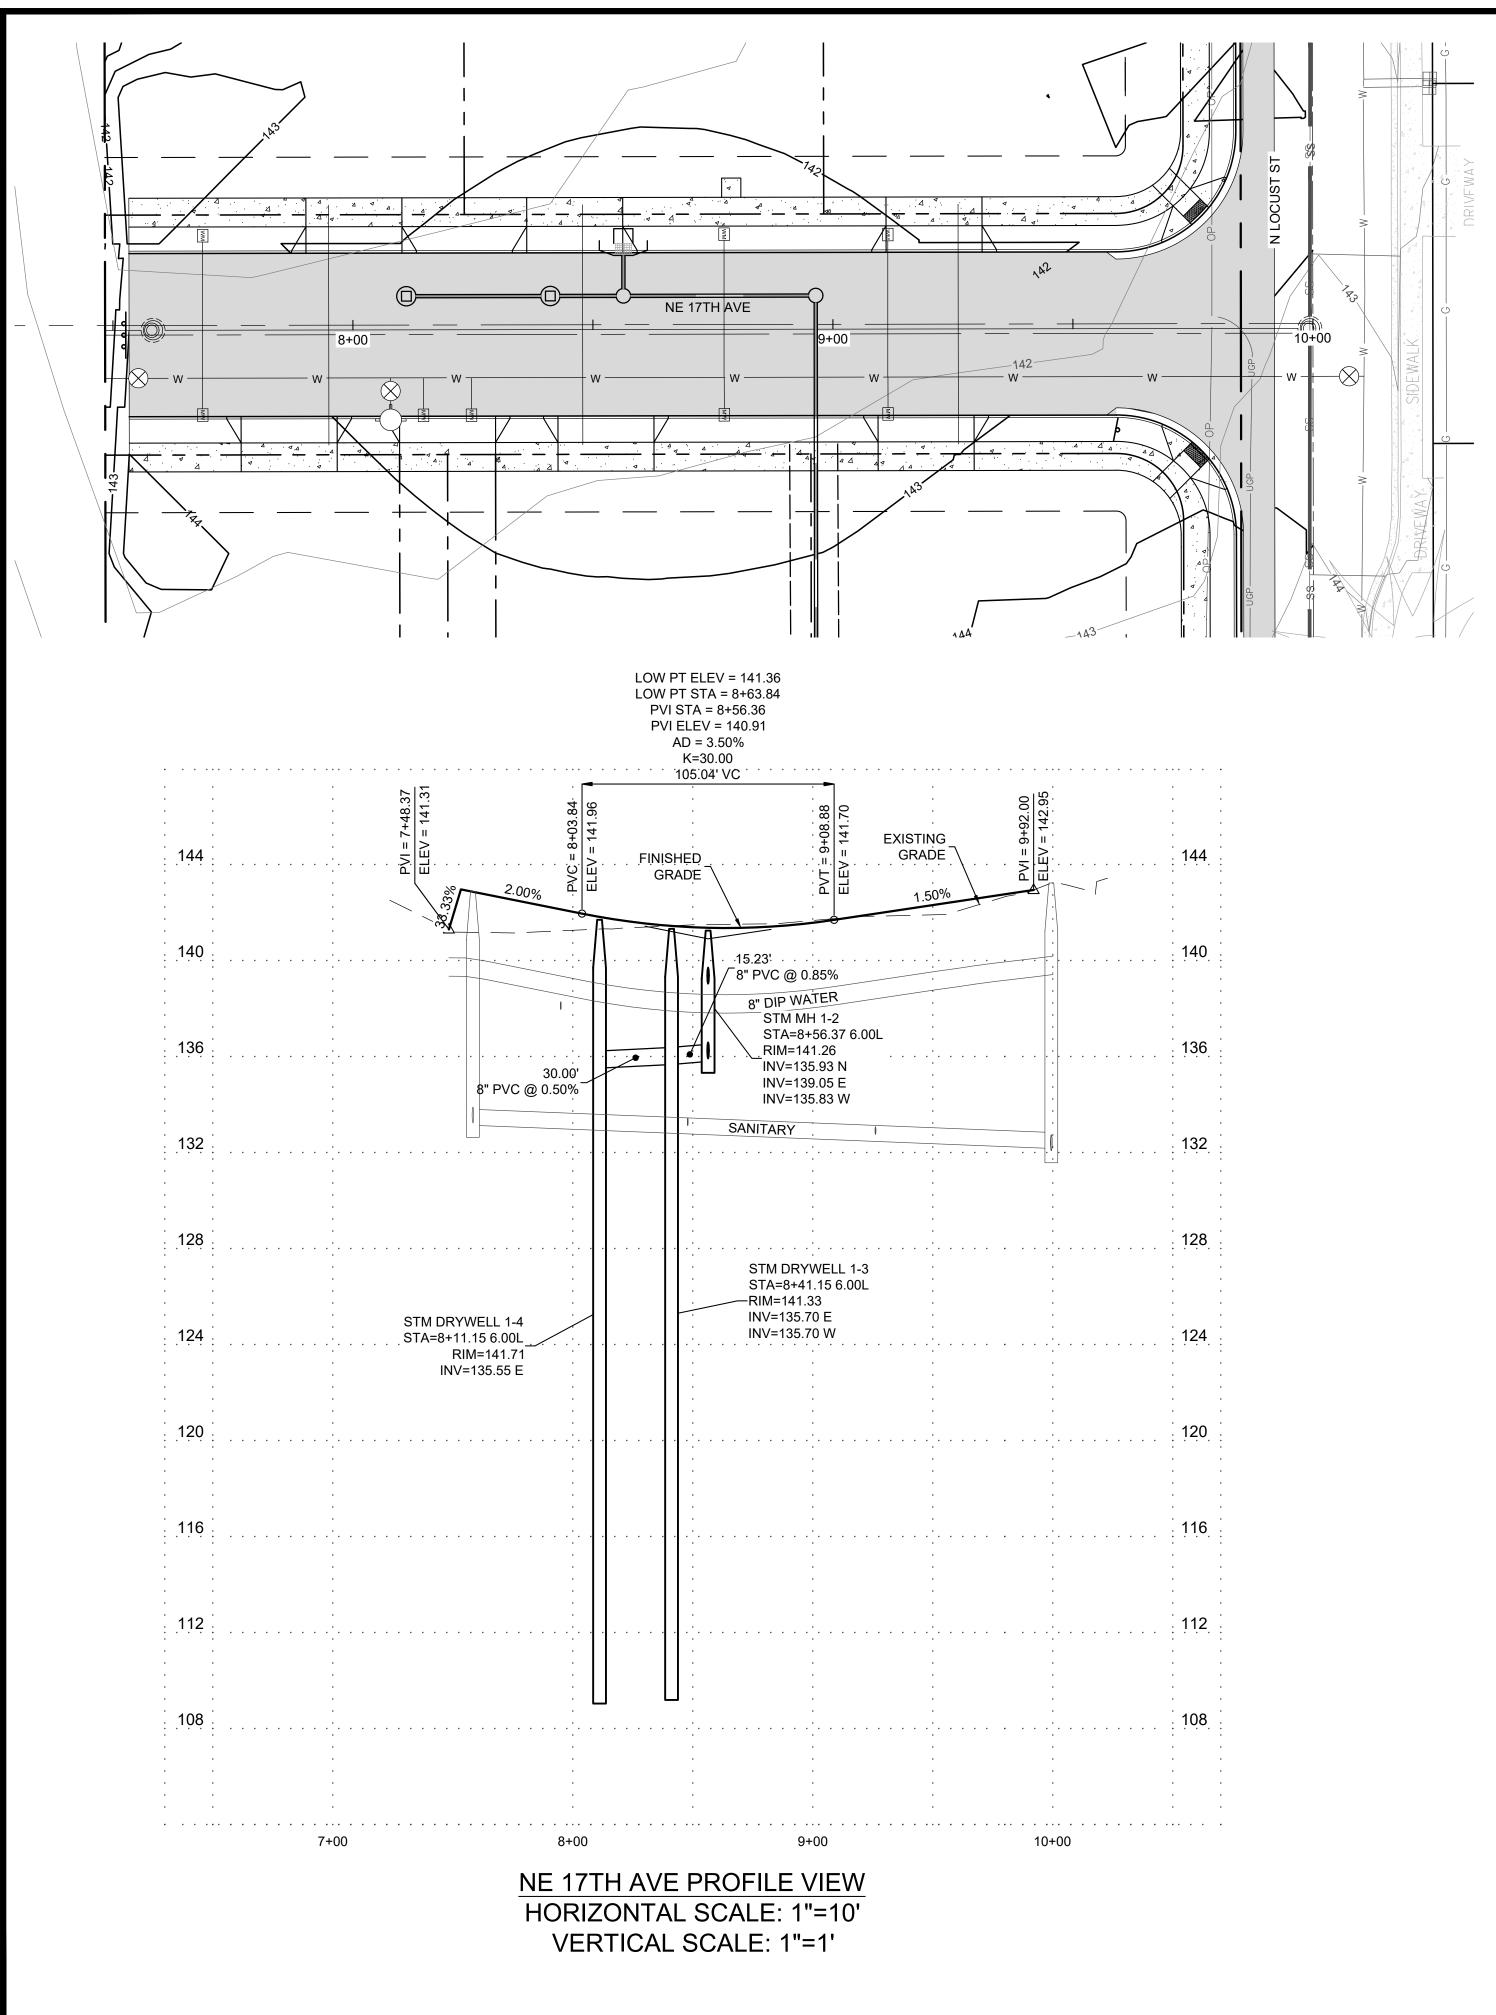


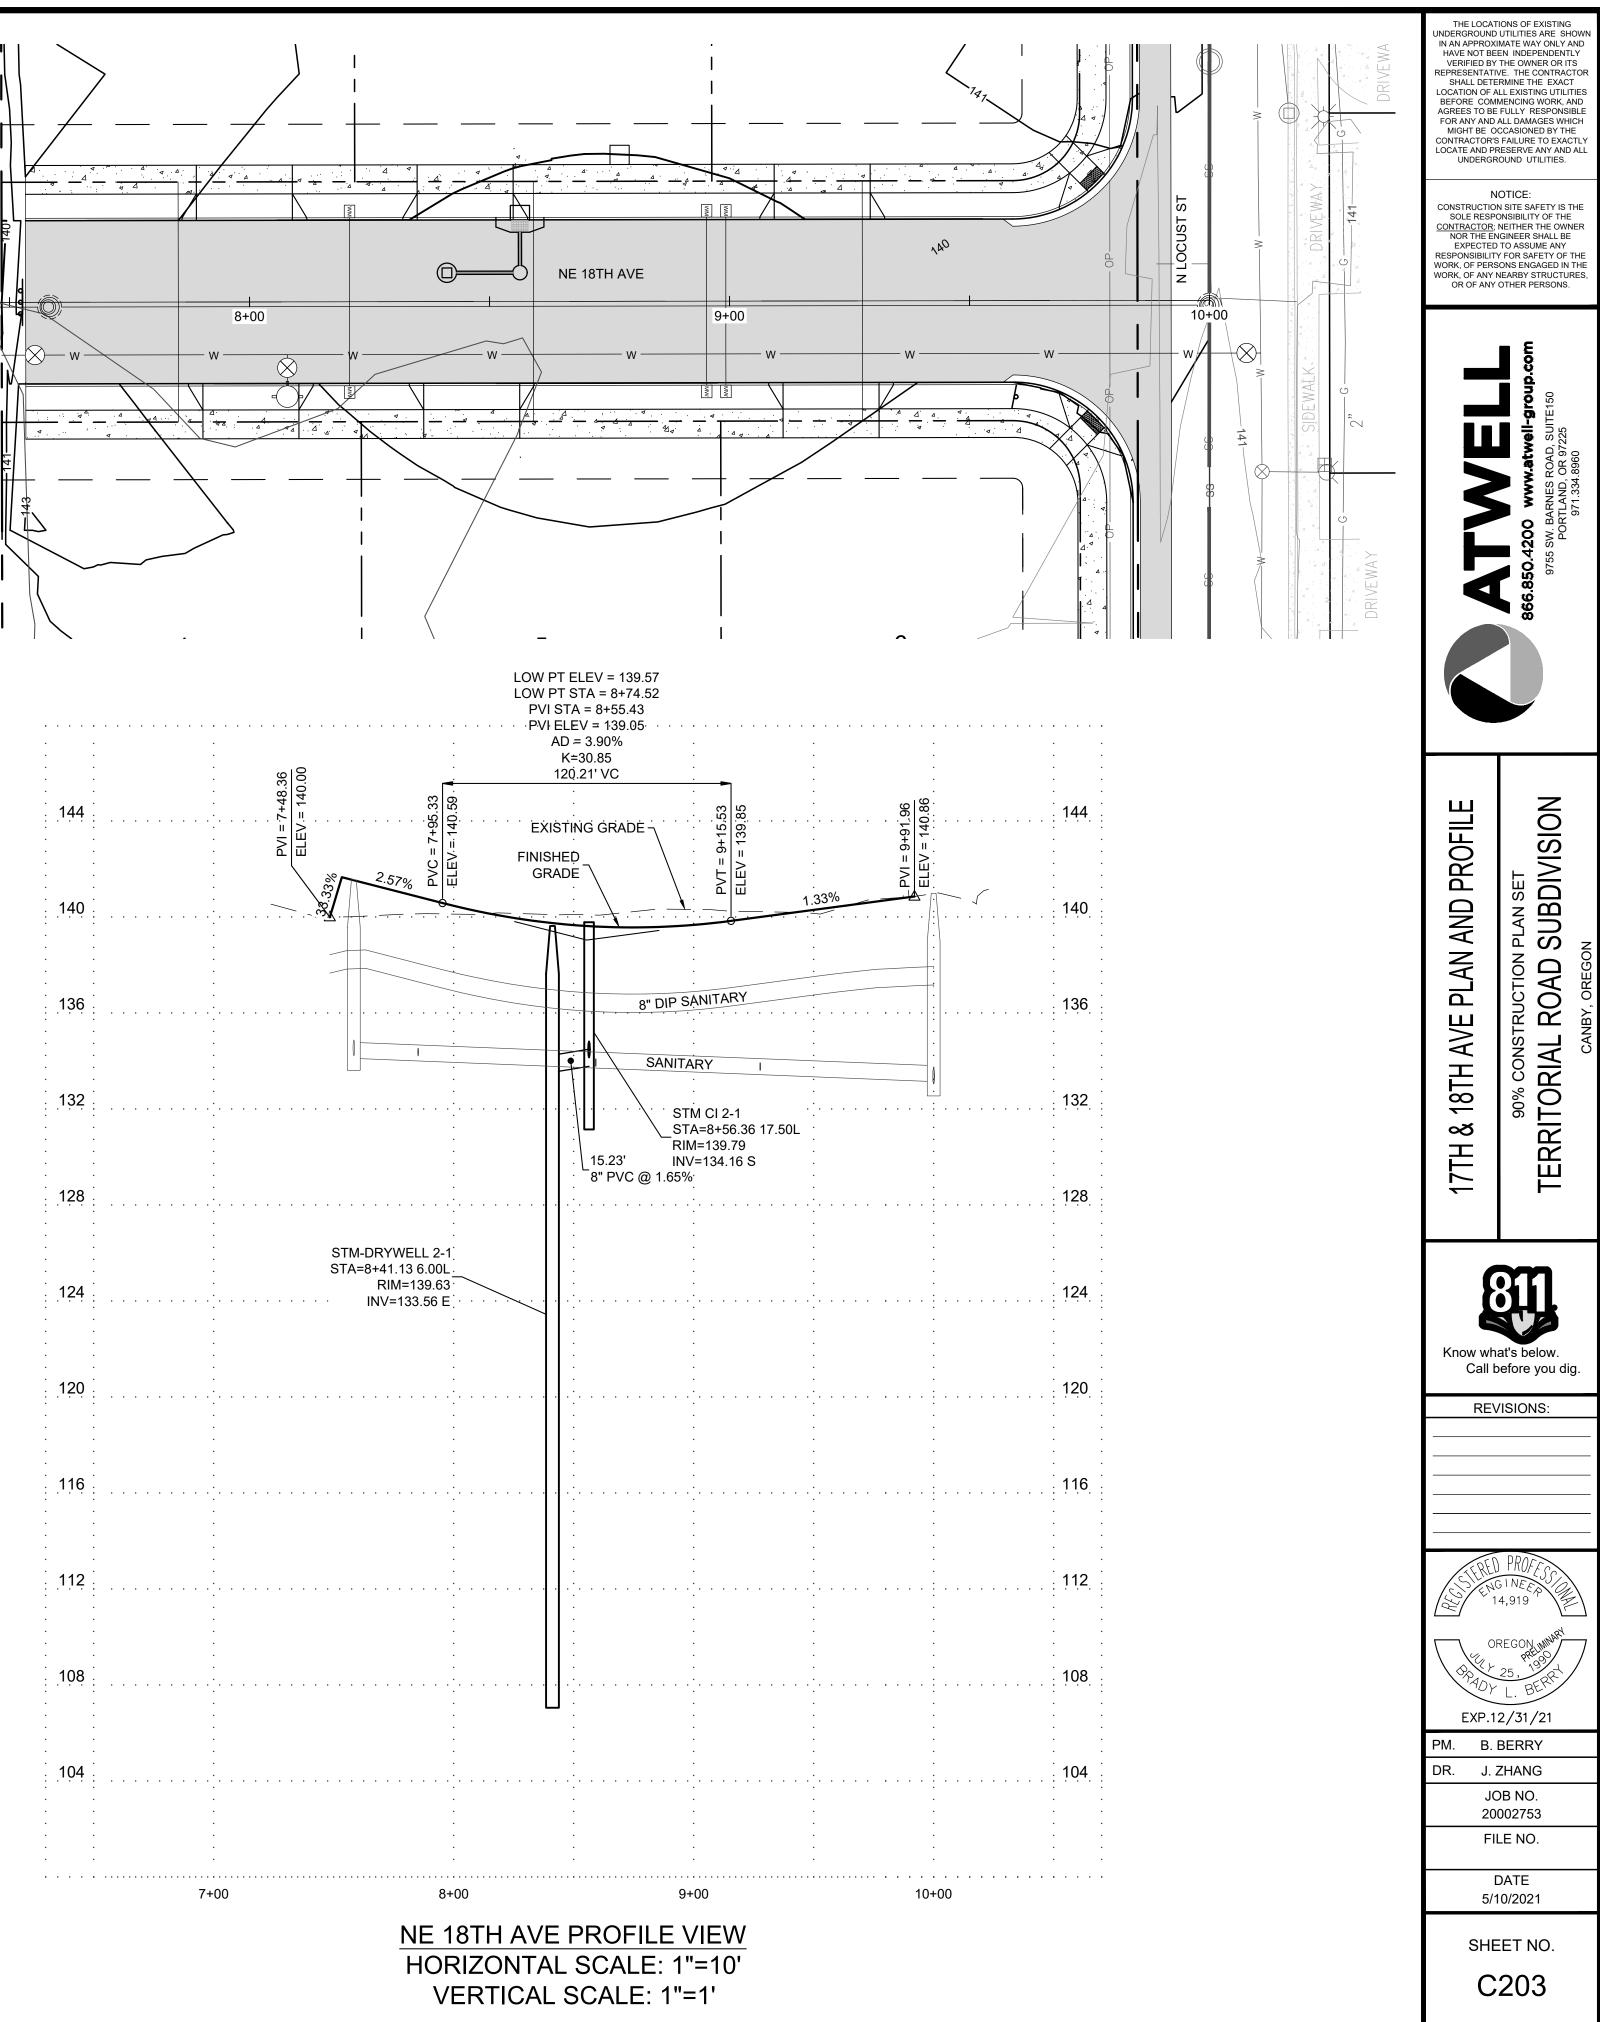

80 80 144 133% 140 136 136 0L 138 128 124 120 116 1112 108 1040 104	• •	•••	 	••••		 	
110. 136. 137. 138. 128. 128. 128. 128. 128. 128. 128. 129. 120. 116. 116. 117. 108. 104.		· · · · · · ·	 VI = 9+91 <u>,96</u> LEV = 140.86	· · · · · ·		 · · · · · · ·	144
L 136. 132. 0L 132. 132. 128. 124. 124. 120. 116. 116. 117. 108. 104.	1	.33%	 ••••			 	140
L 132. 0L 128. 128. 124. 120. 116. 116. 118. 108. 104.		· · · · · · ·	 	7.		 · · · · ·	136
124 120 116 112 108 104	0L						132
120 116 112 112 108 104		· · · · · · ·	 	· · · · · ·		 · · · ·	128
116 112 108 104			 			 	124
112 108 104			 				120
108.			 				116
			 				112
			 				108
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			 	• • • • •	••	 	

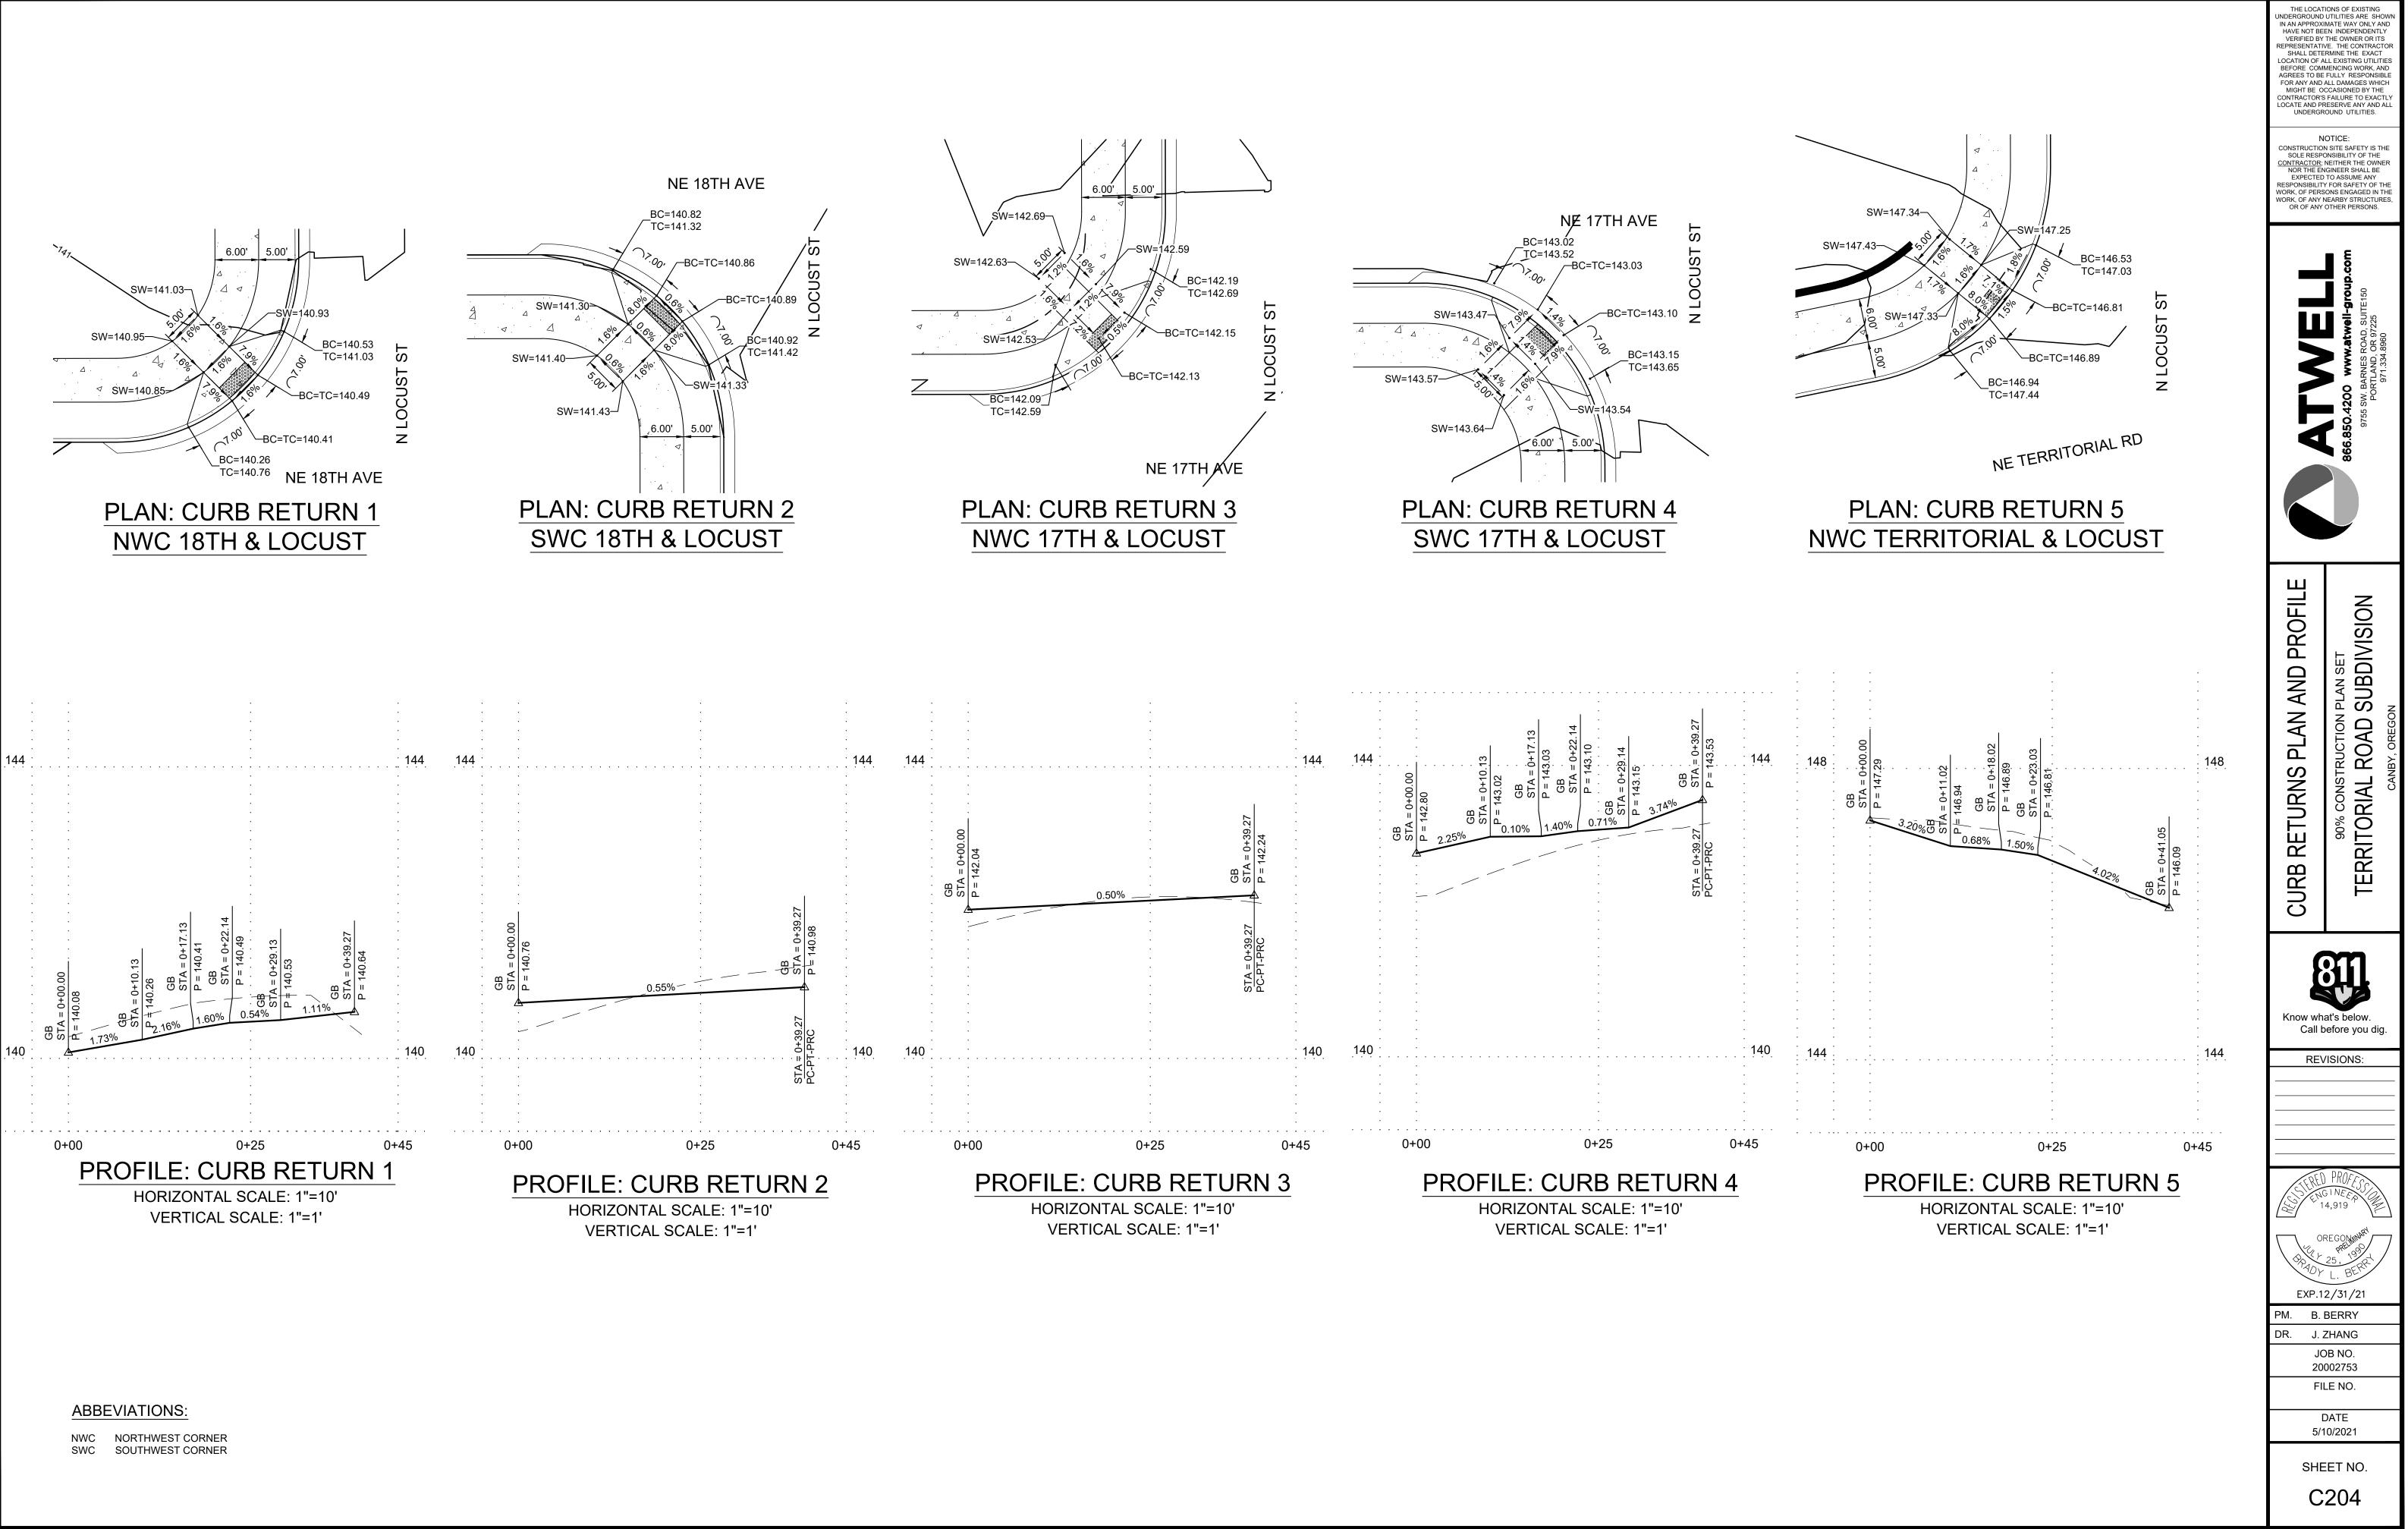

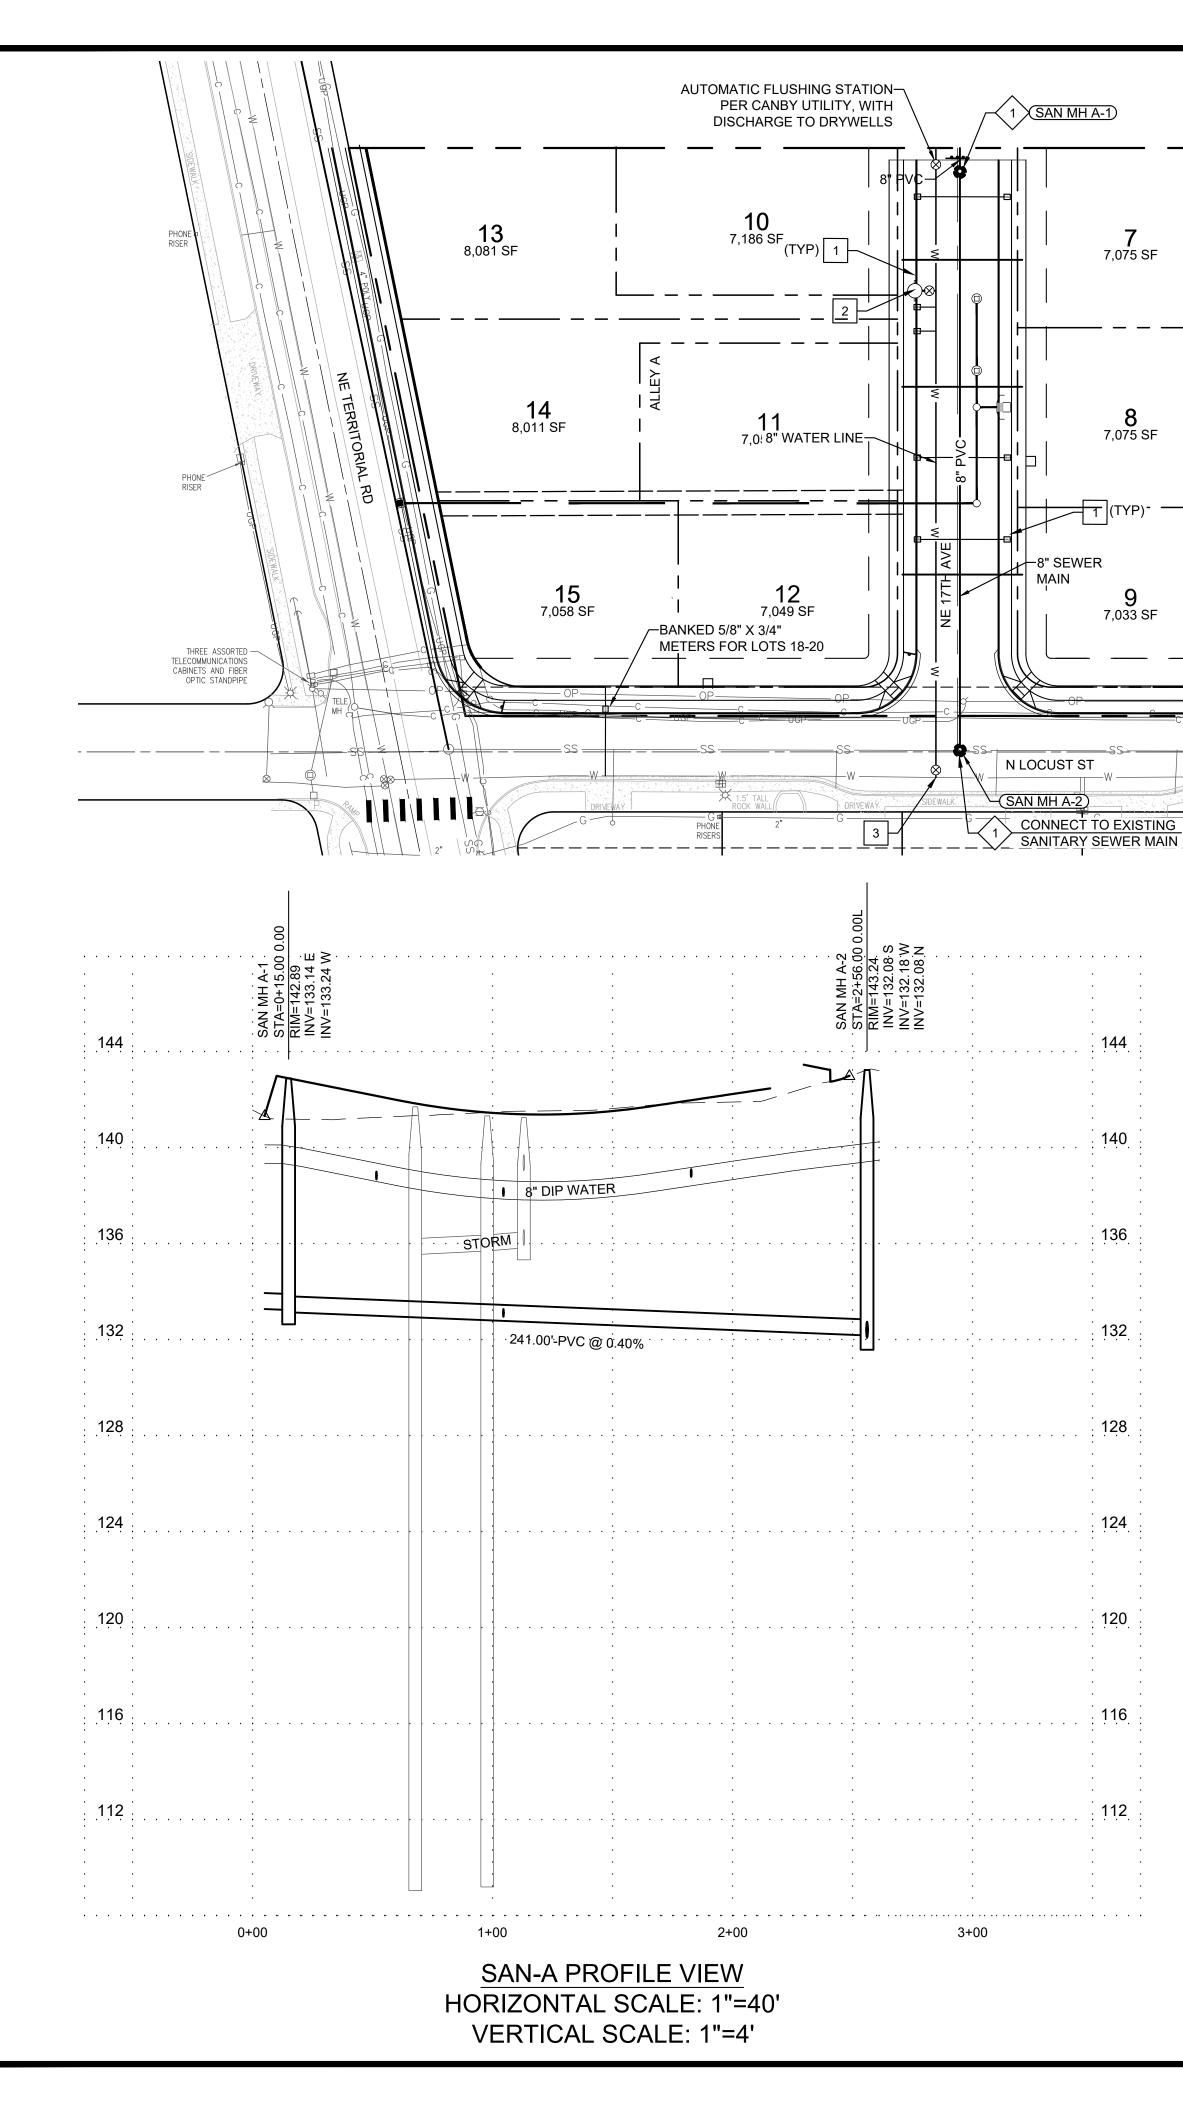

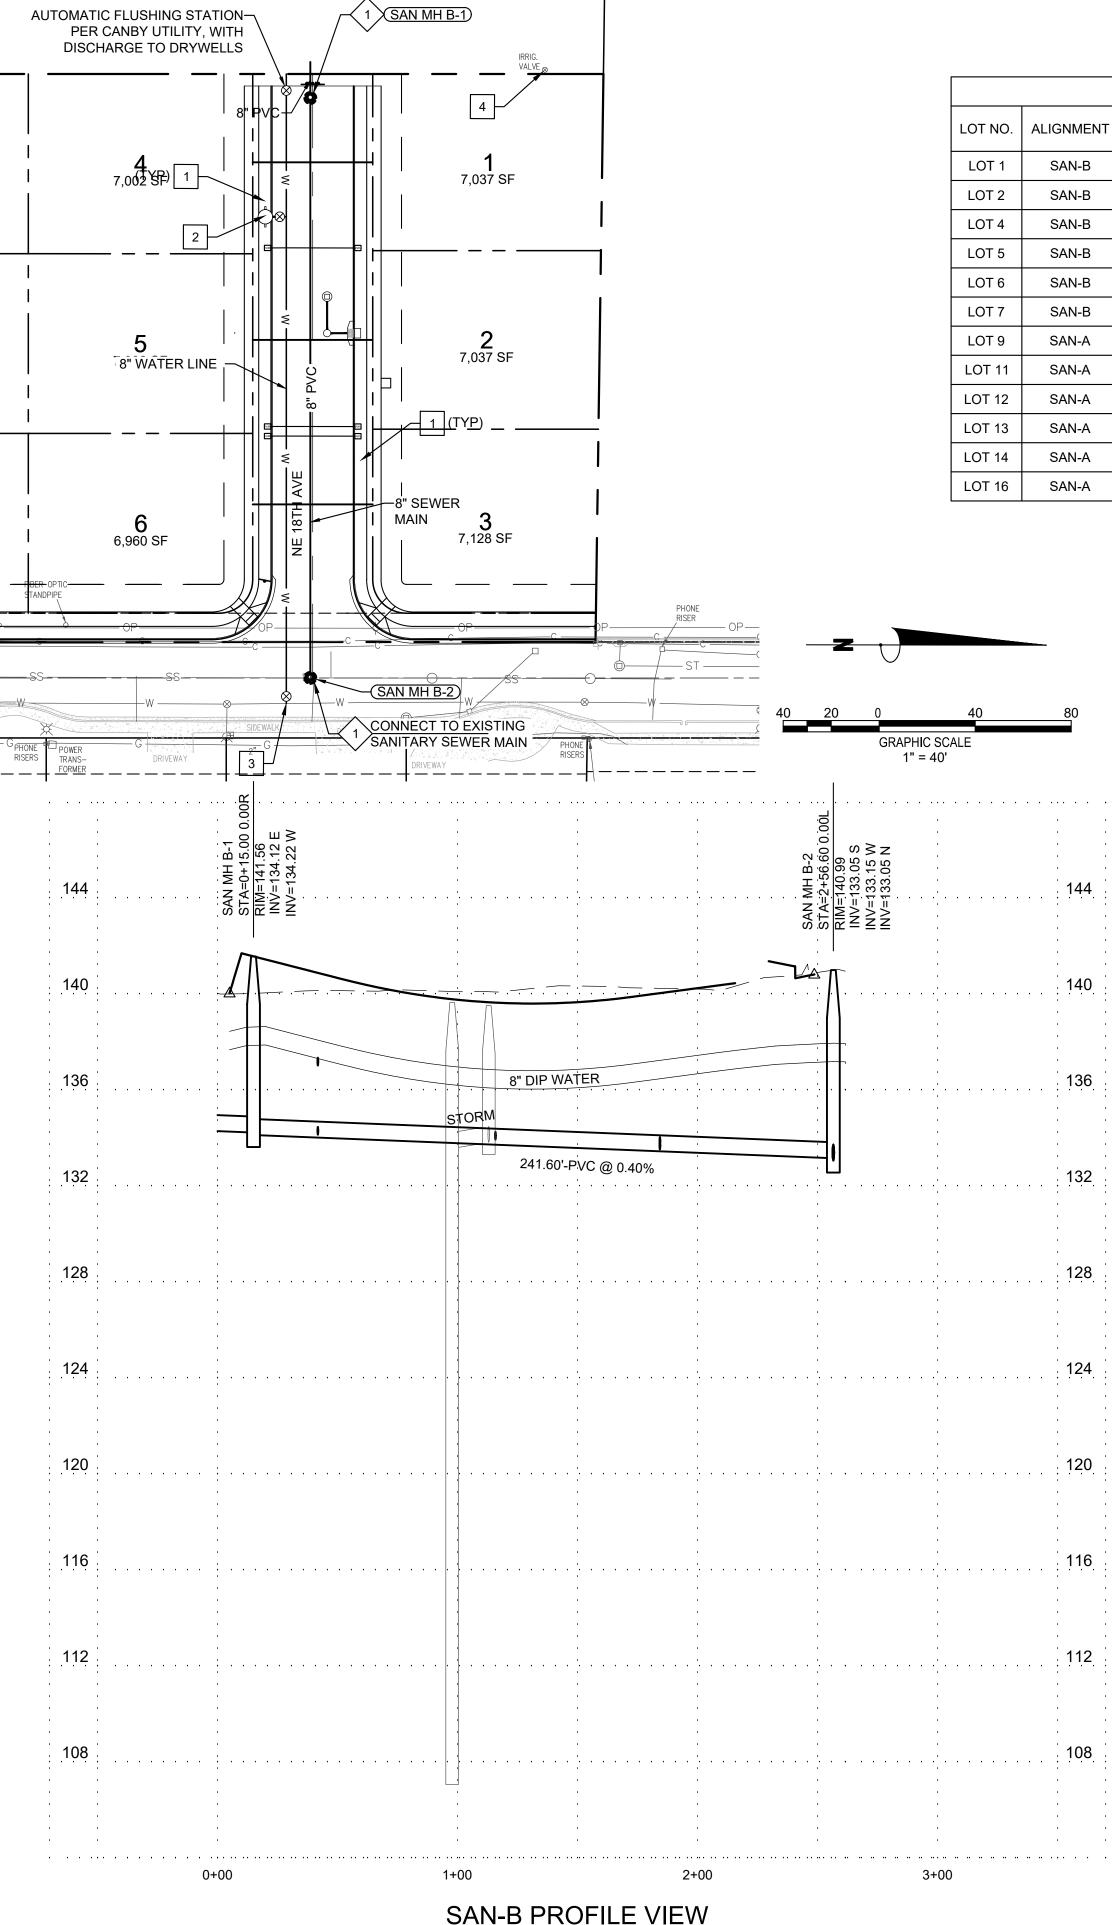

SAN-B PROFILE VIEW HORIZONTAL SCALE: 1"=40' VERTICAL SCALE: 1"=4'


	SANITARY LATERAL SCHEDULE							
Т	LENGTH	SIZE	INV. ELEV @ MAINLINE	INV. ELEV. @ PLUG	SLOPE	DEPTH @ PLUG		
	26'	4"	133.53	136.13	0.10	3.88		
	26'	4"	133.71	135.79	0.08	3.82		
	26'	4"	134.14	136.48	0.09	4.37		
	24'	4"	137.03	137.03	0.00	4.50		
	24'	4"	133.94	136.34	0.10	3.95		
	24'	4"	133.72	136.36	0.11	4.33		
	26'	4"	132.55	138.27	0.22	3.69		
	26'	4"	132.97	137.39	0.17	4.02		
	26'	4"	137.98	137.98	0.00	4.16		
	24'	4"	138.69	138.69	0.00	4.13		
	24'	4"	138.01	138.01	0.00	4.08		
	24'	4"	138.80	138.80	0.00	3.85		


SANITARY SEWER KEY NOTES

2. 4" SEWER LATERAL WITH CLEANOUT, TEE-WYE TO MAIN

WATER AND FIRE KEYED NOTES #

- 1. DOUBLE 5/8" x 3/4" WATER METERS FOR SINGLE FAMILY RESIDENTIAL SERVICE, 18" BEHIND PLANTER STRIP
- 2. FIRE HYDRANT
- 3. 8" GATE VALVE, CONNECT TO EXISTING 8" WATER LINE
- 4. DISCONNECT AND REMOVE EXISTING IRRIGATION VALVE AND ASSOCIATED SPRINKLER SYSTEM

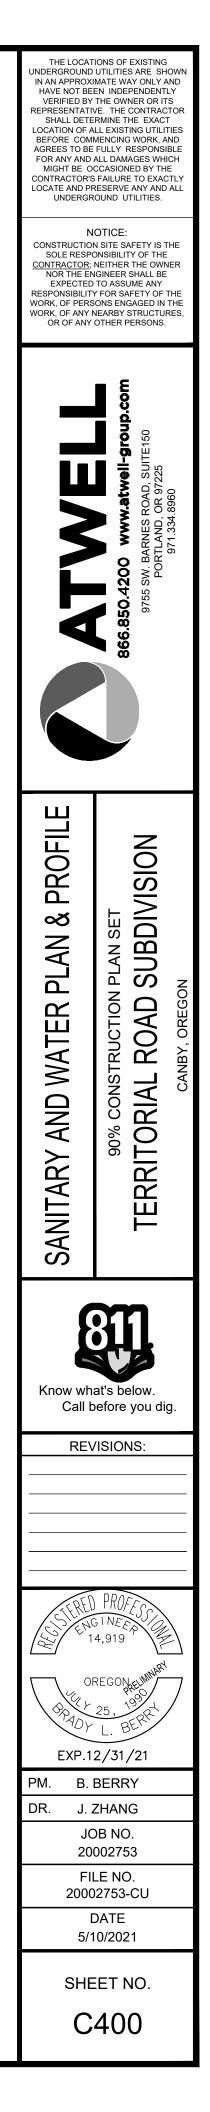

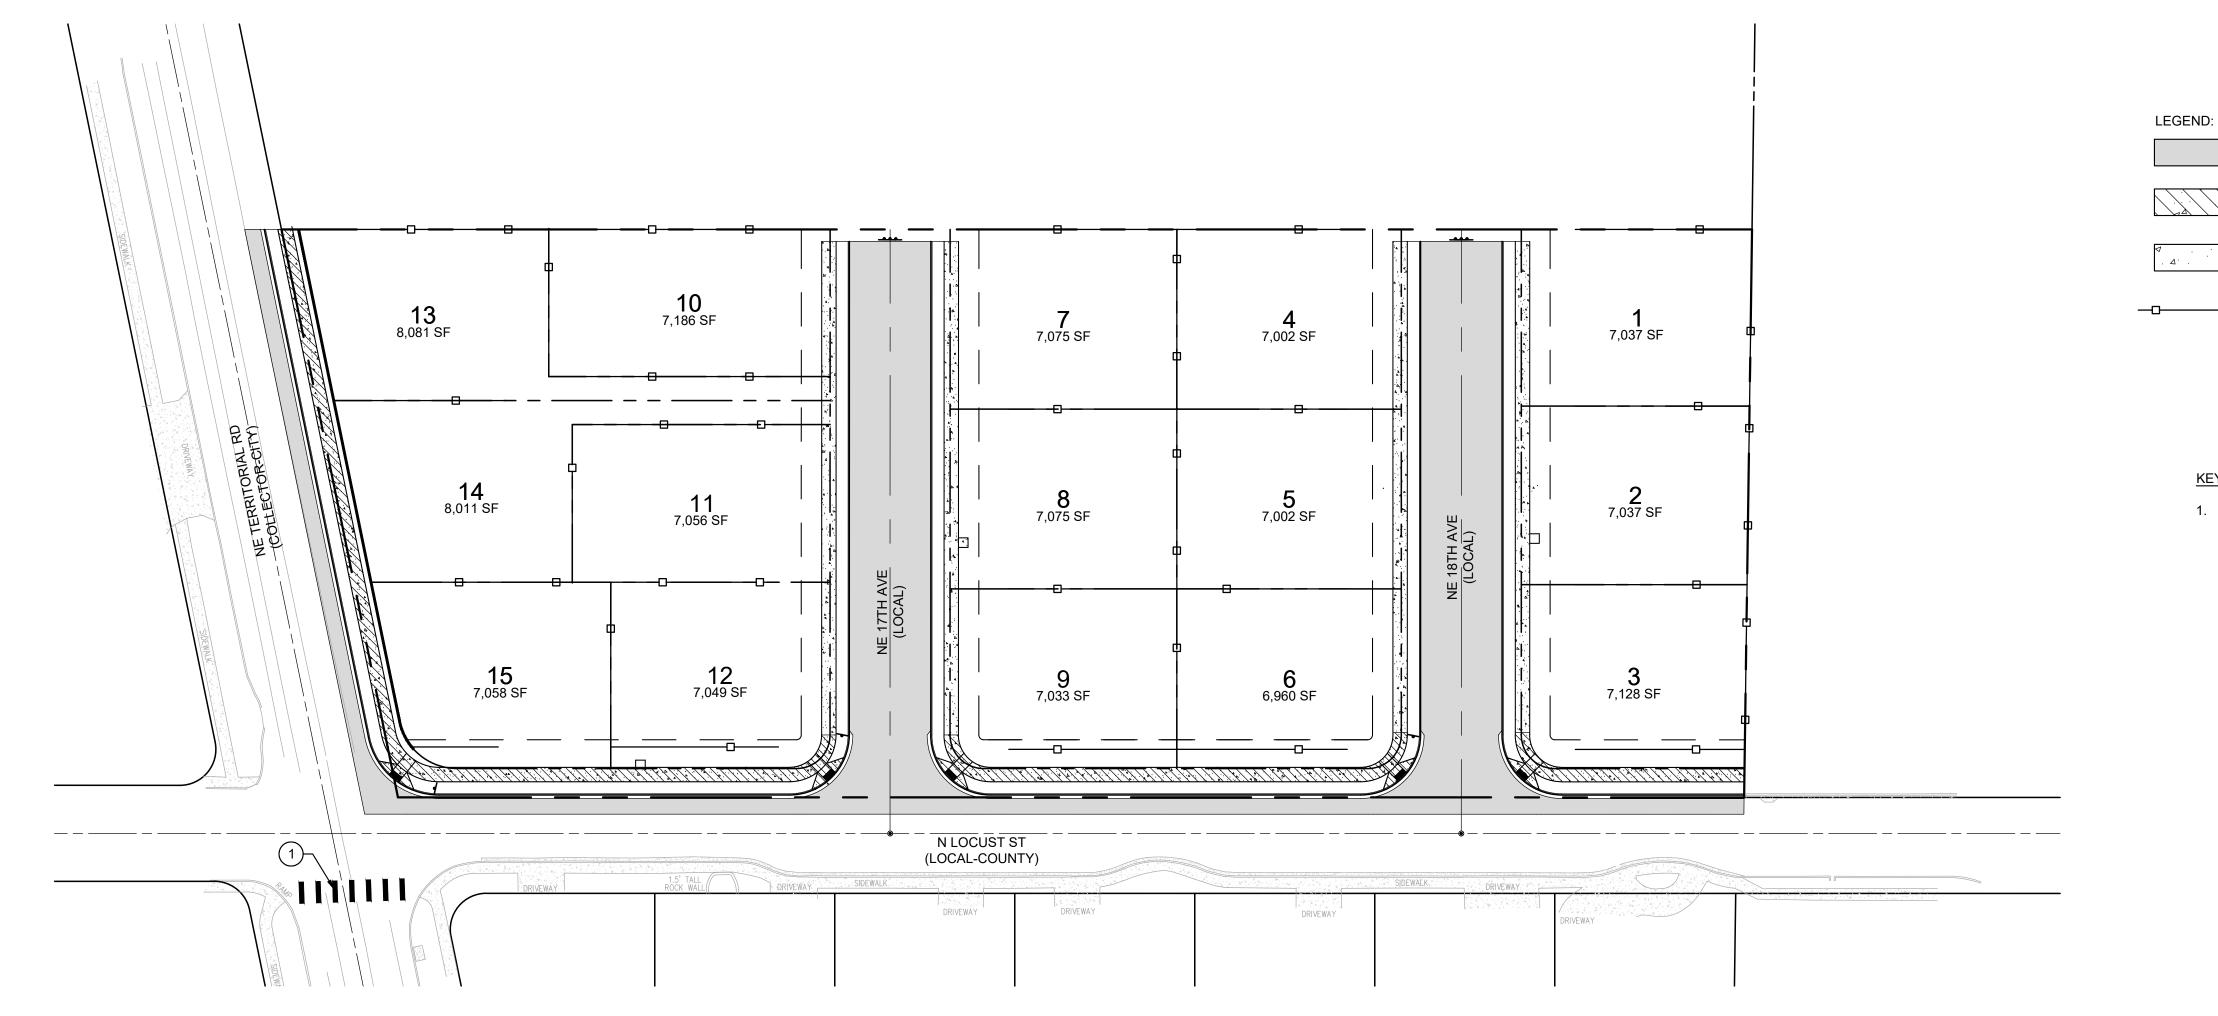



GRAPHIC SCALE 1" = 40'

D:	
	ASPHALT
	CONCRETE SIDEWALK TO BE CONSTRUCTED WITH SITE WORK
	CONCRETE SIDEWALK TO BE CONSTRUCTED AT TIME OF HOME CONSTRUCTION
	6' GOOD NEIGHBOR STYLE WOOD FENCE TO BE CONSTRUCTED AT TIME OF HOME CONSTRUCTION

KEY NOTES (#):


CROSSWALK STRIPING, SEE CROSSWALK STRIPING DETAIL D, DWG. NO. 114 ON SHEET C701.

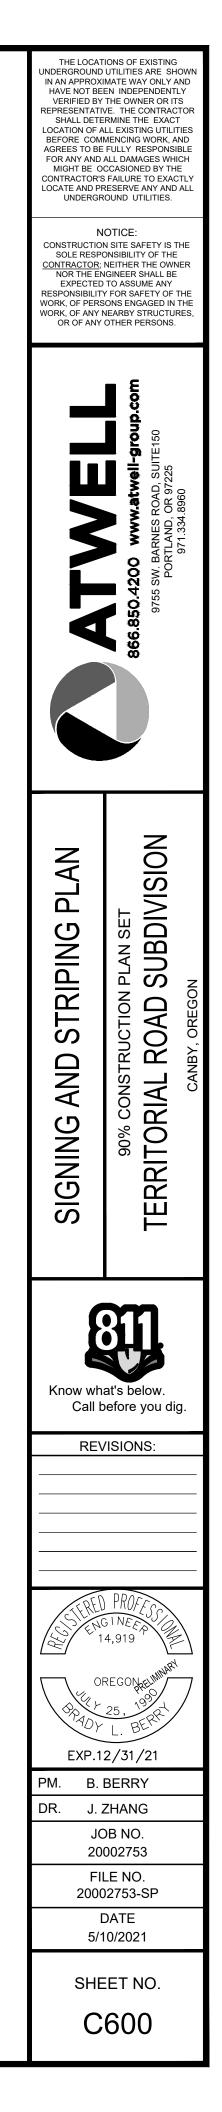


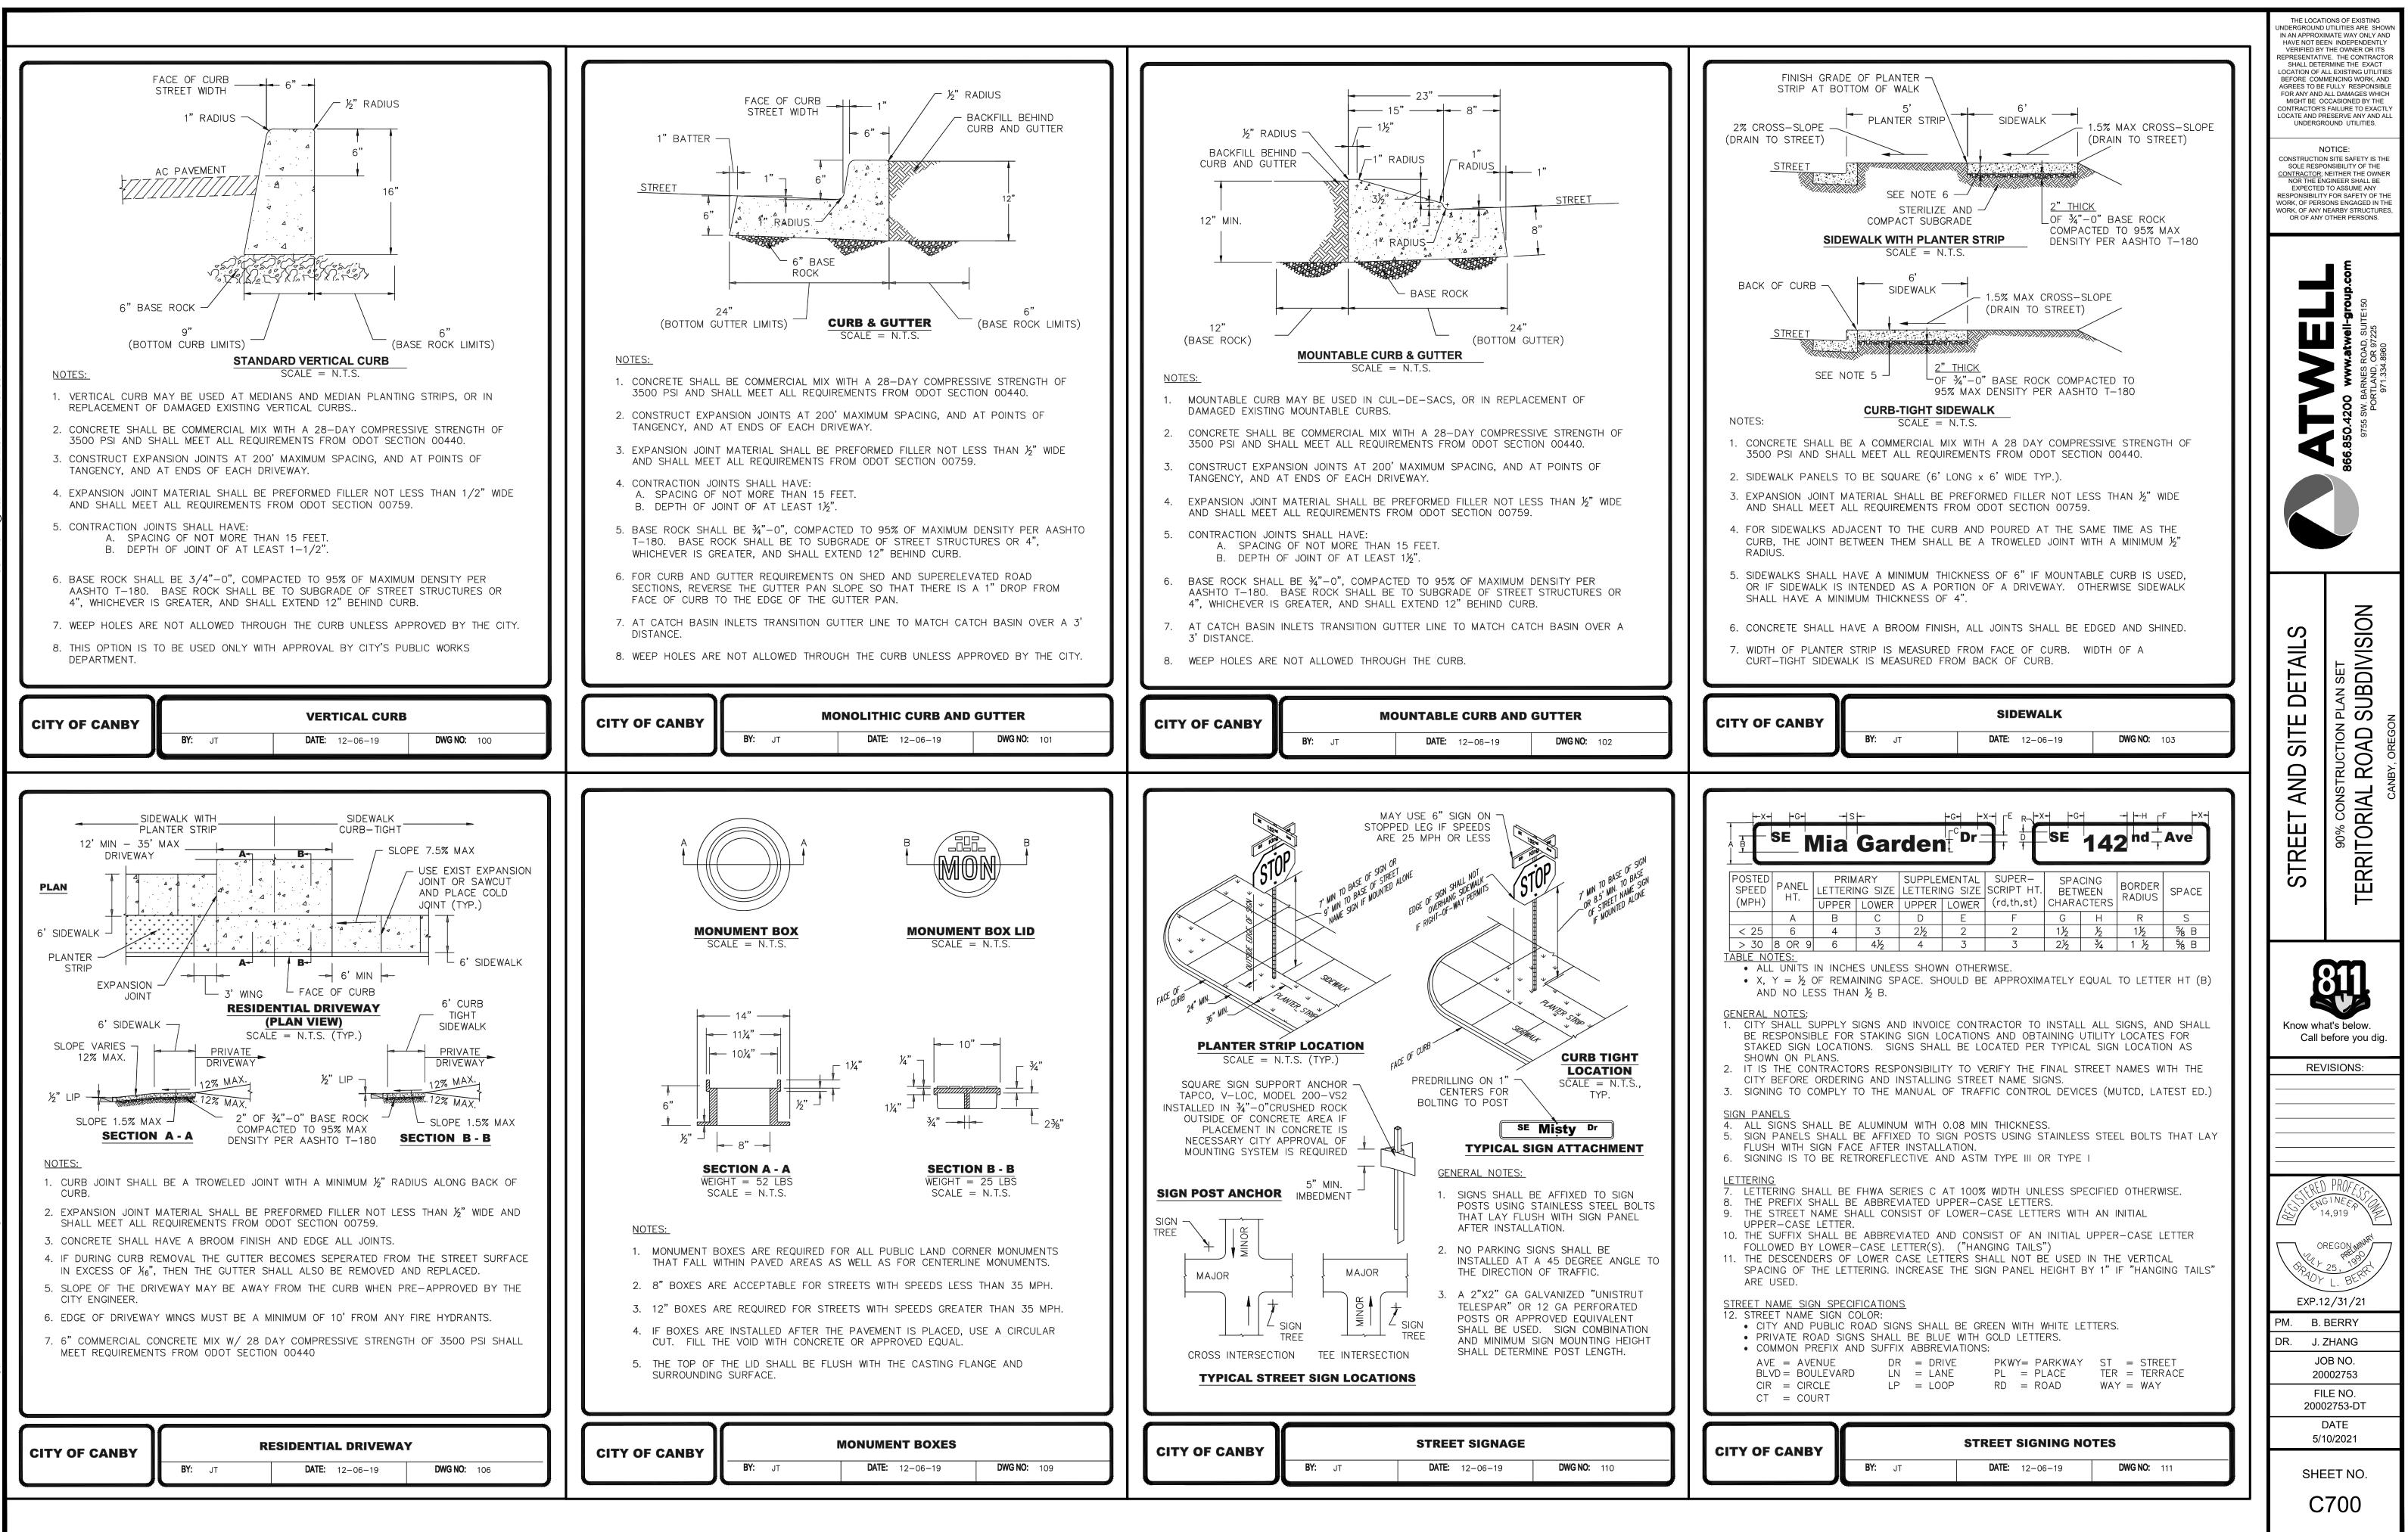

002753 - territorial road subdivision\dwg\plan sets\site-final\20002753-details




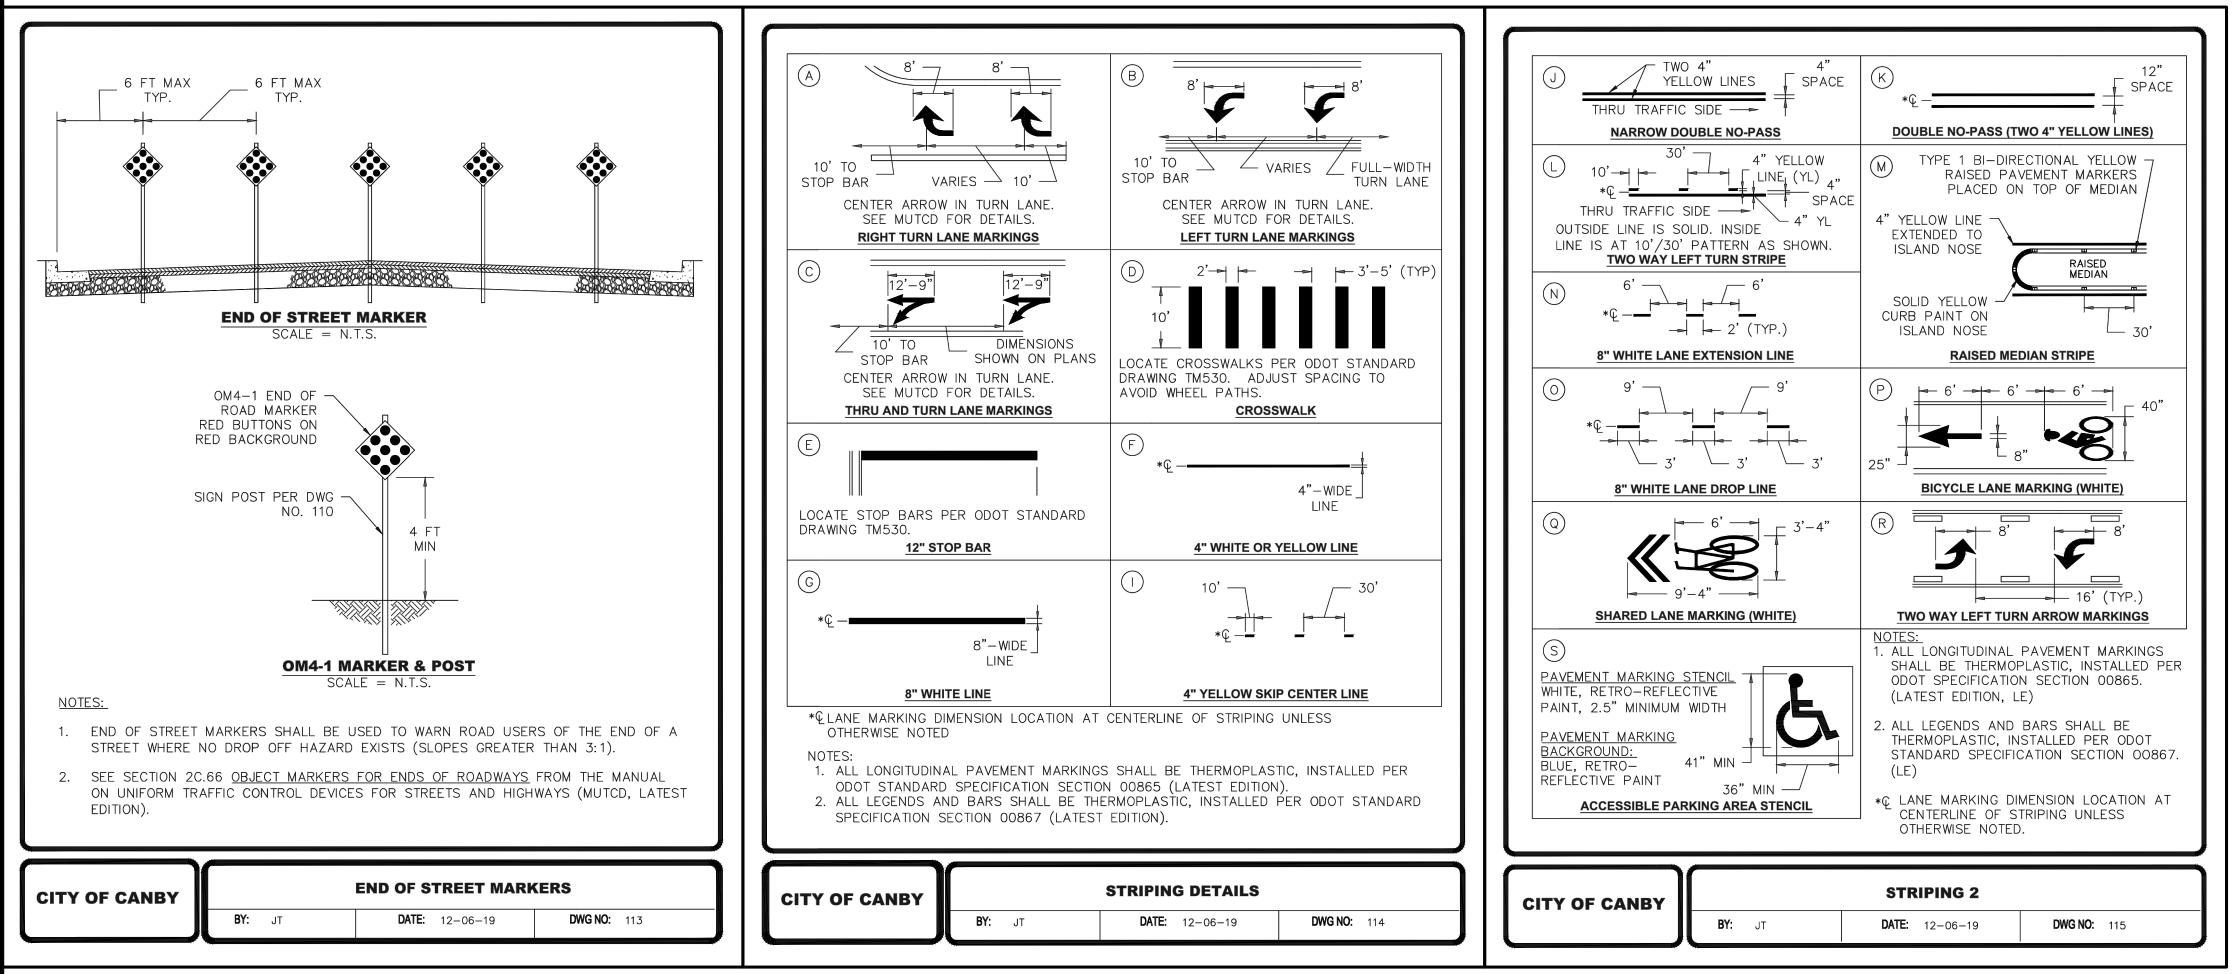


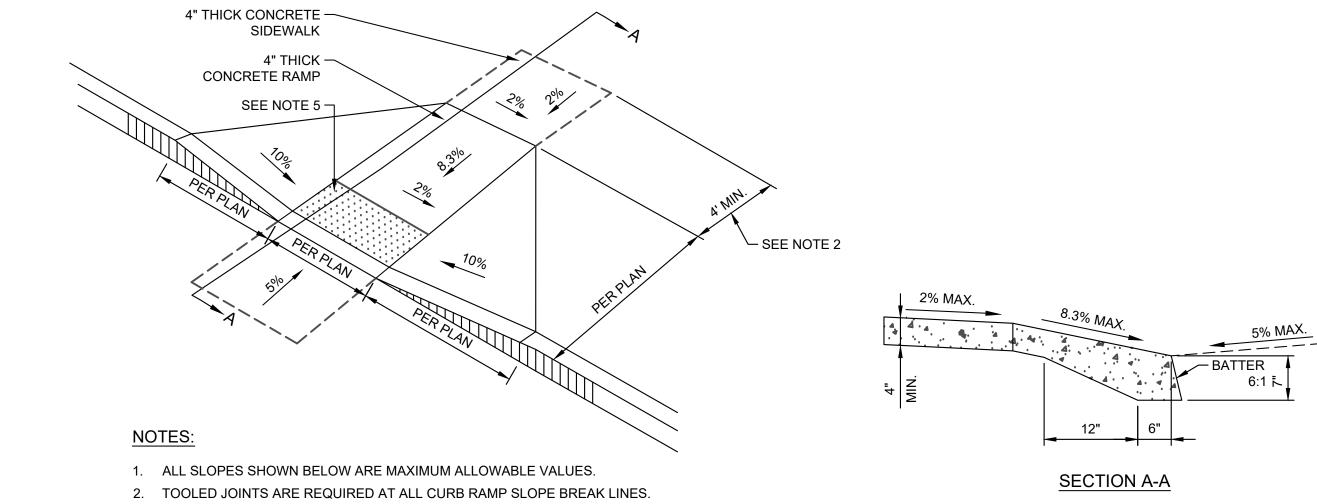



- 3. CONCRETE COMPRESSIVE STRENGTH SHALL BE PER SPECS.
- 4. CURB RAMP SLOPES ARE RELATIVE TO TO THE TRUE LEVEL HORIZON (ZERO BUBBLE).
- 5. DETECTABLE WARNING SURFACE SHALL EXTEND MIN. 2' IN DIRECTION OF PEDESTRIAN TRAVEL AND FULL WIDTH OF RAMP. TRUNCATED DOMES PER X/CXX.X




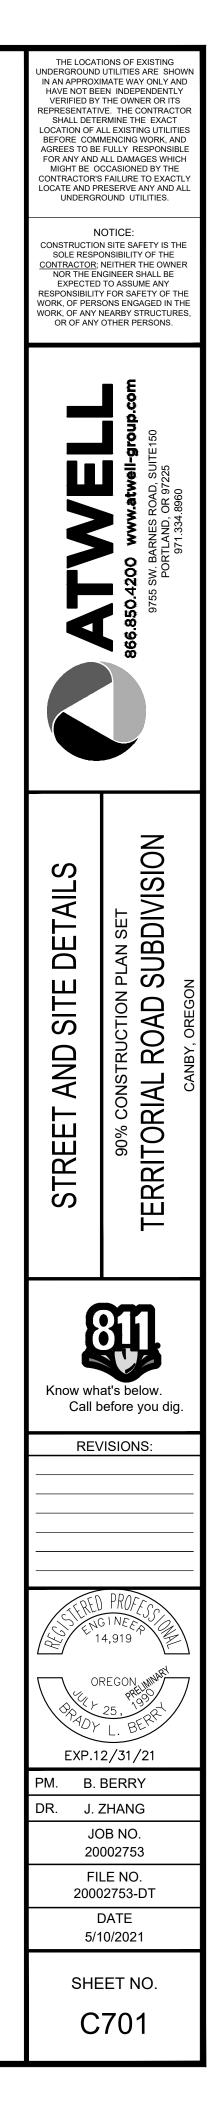


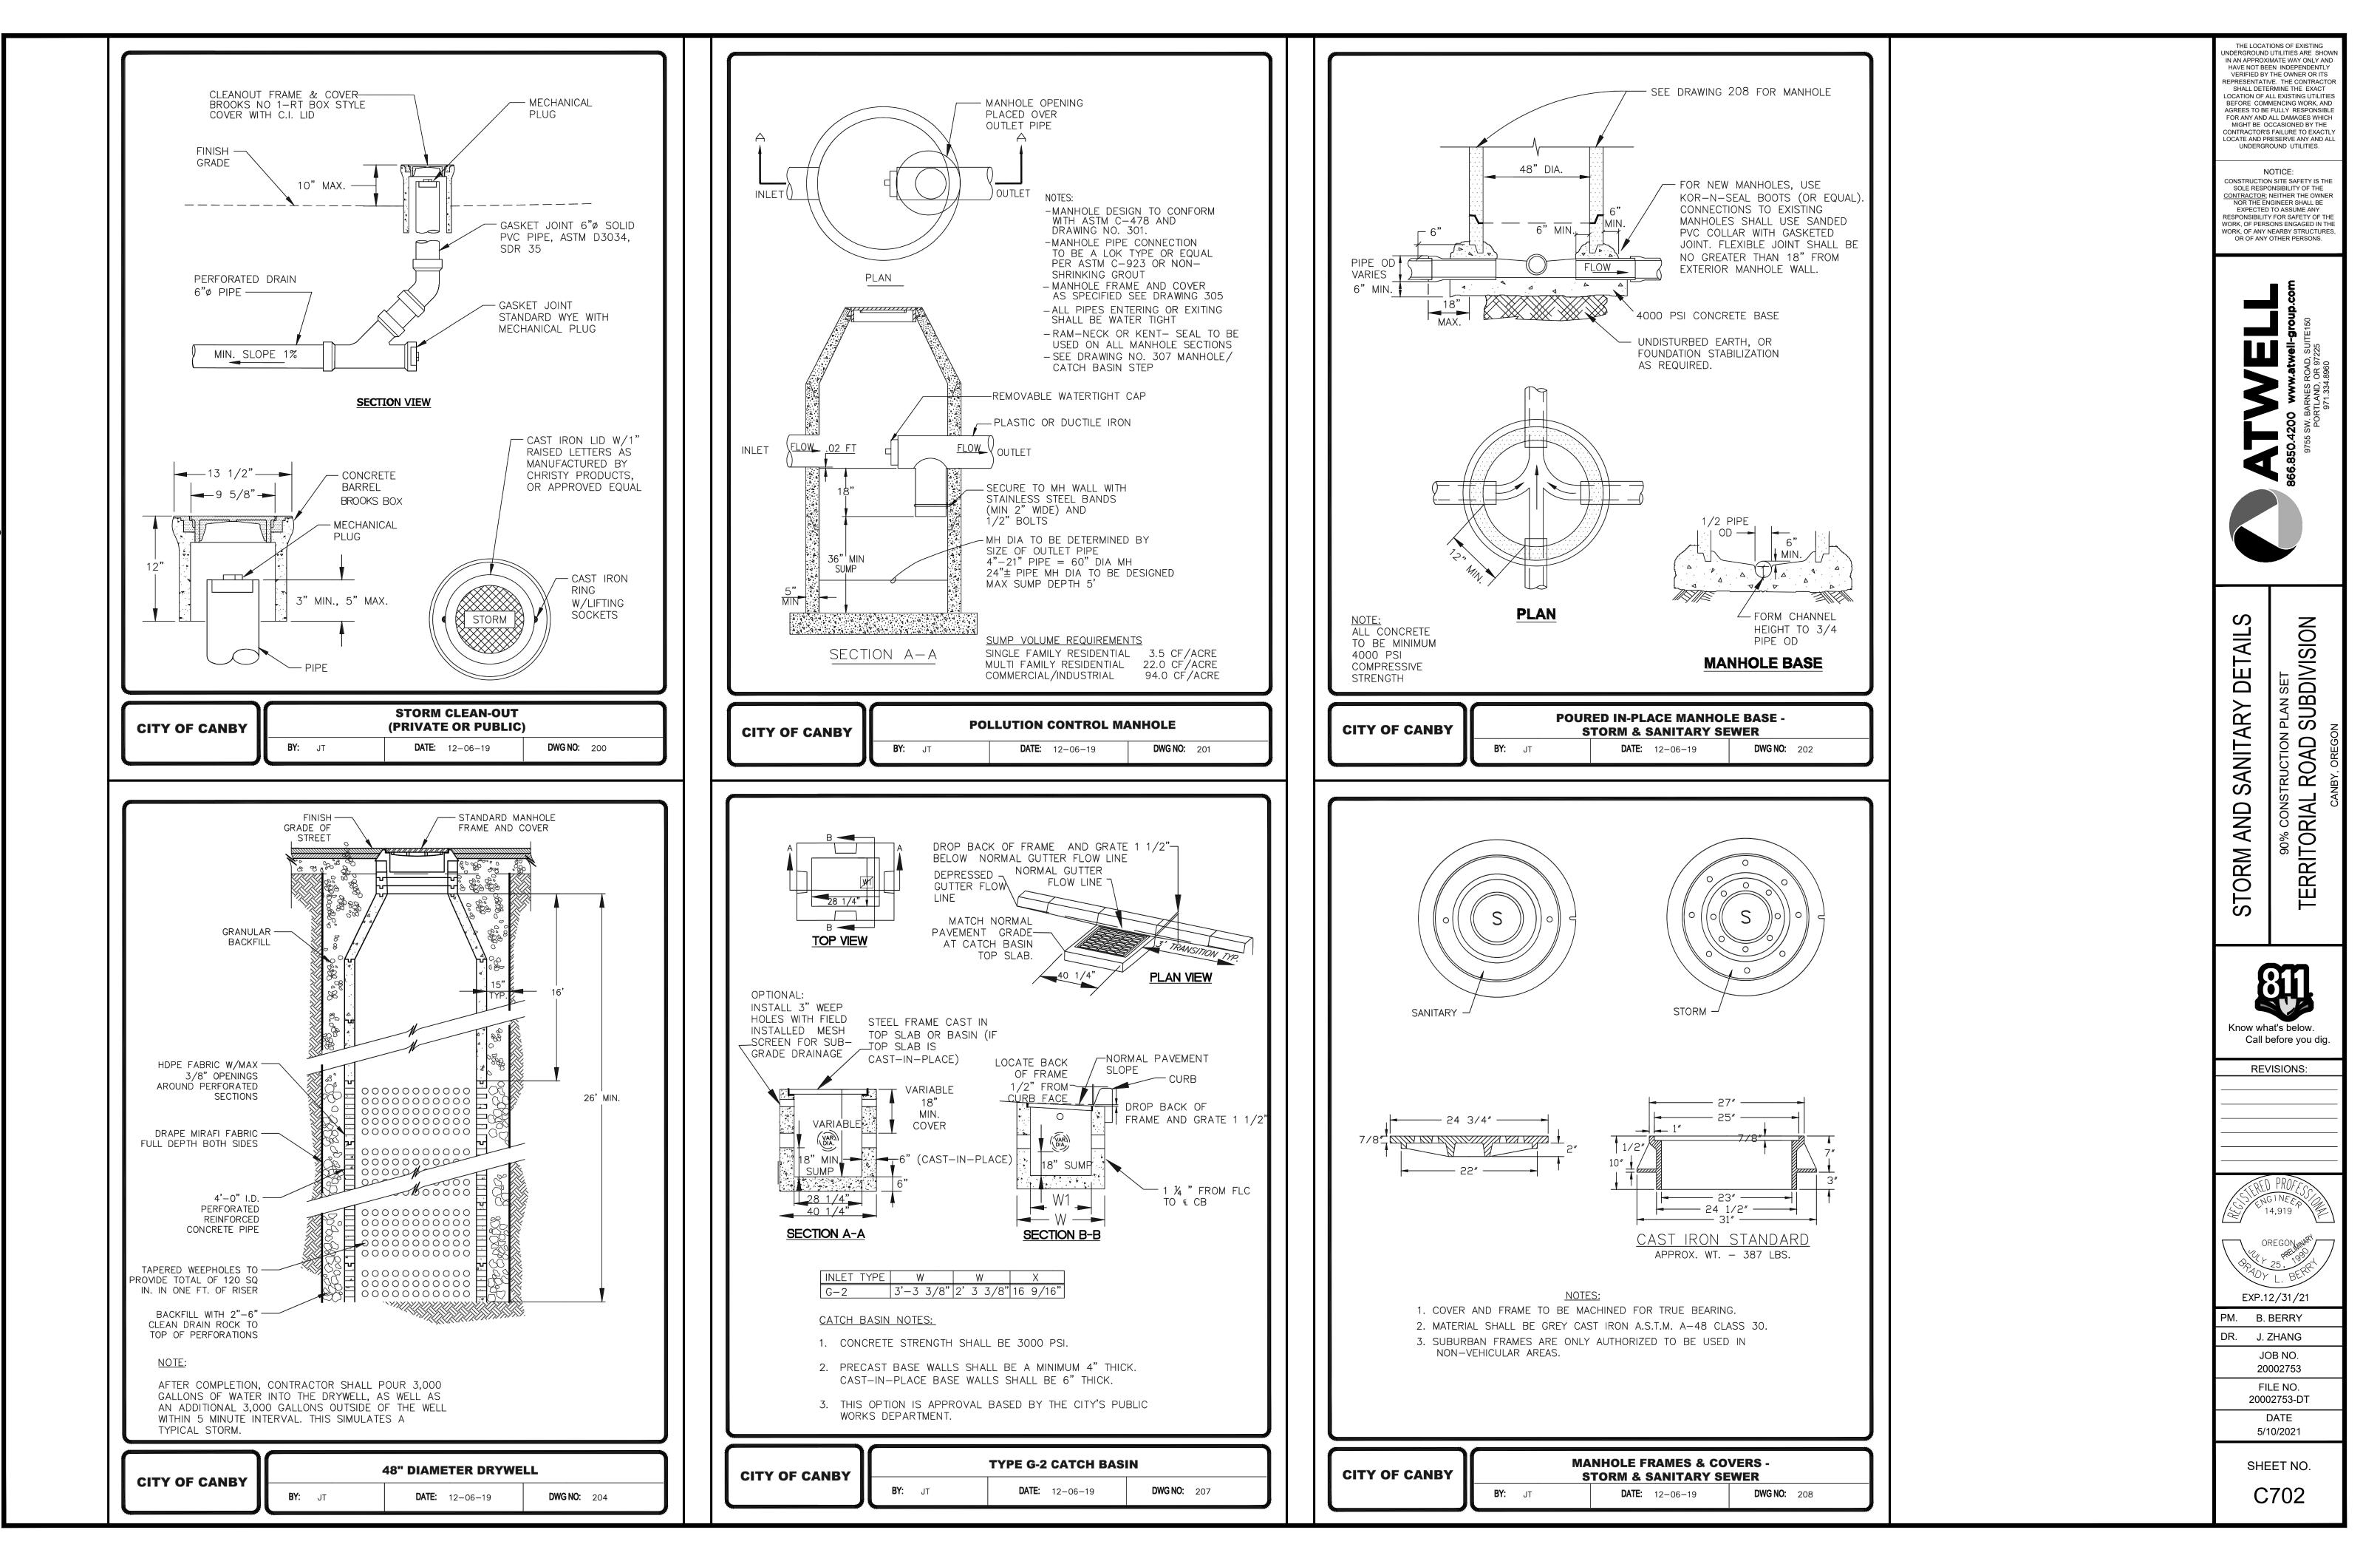

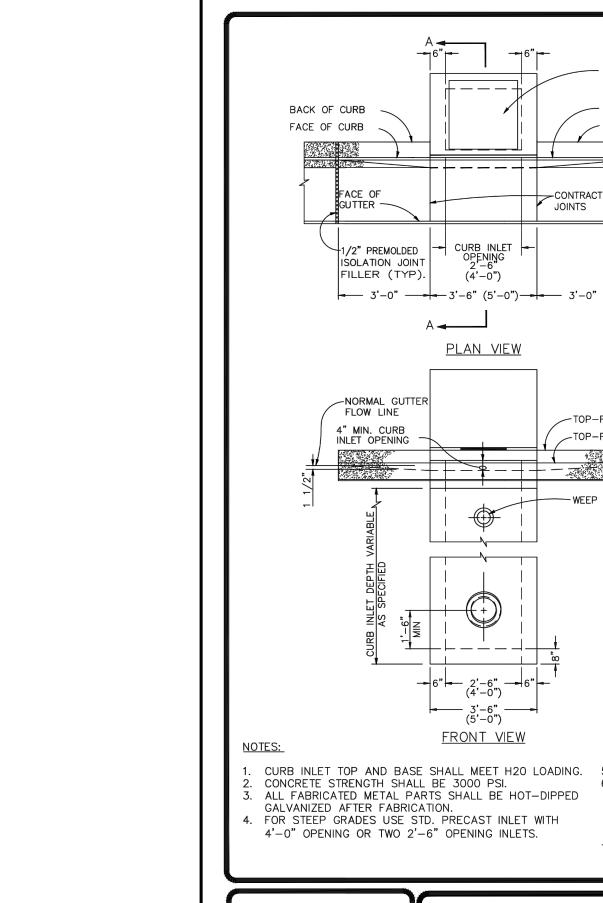

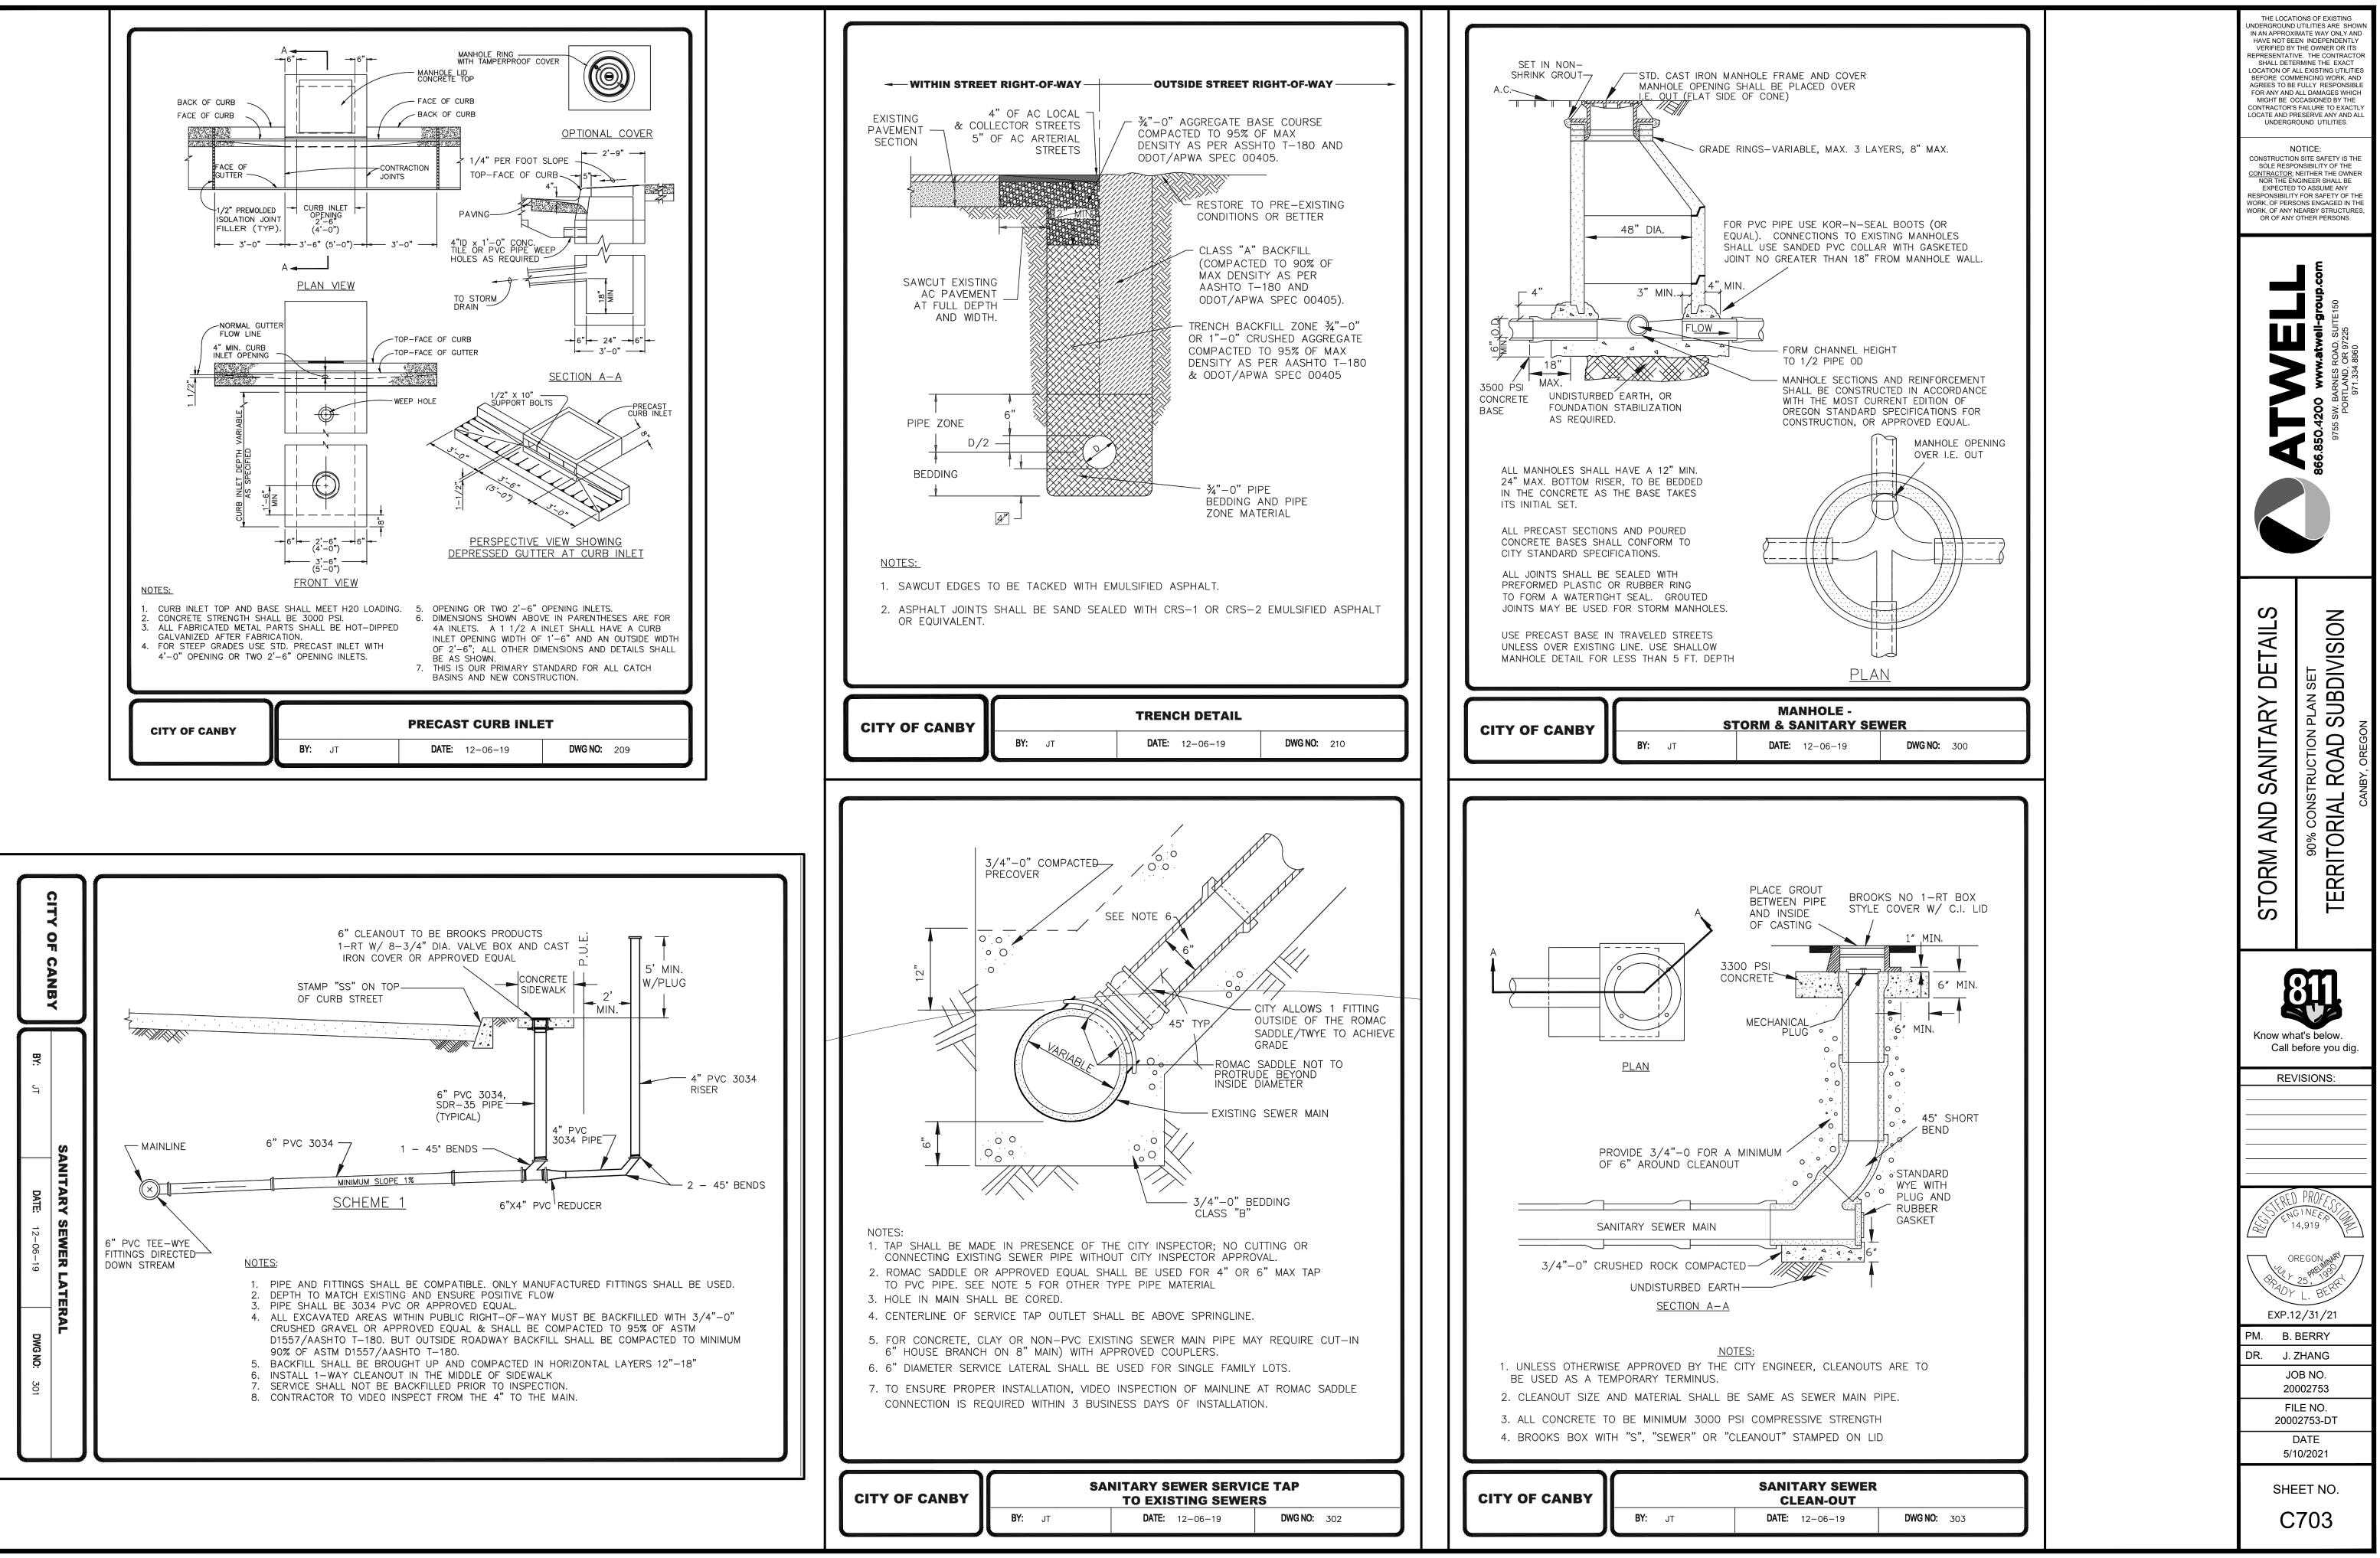

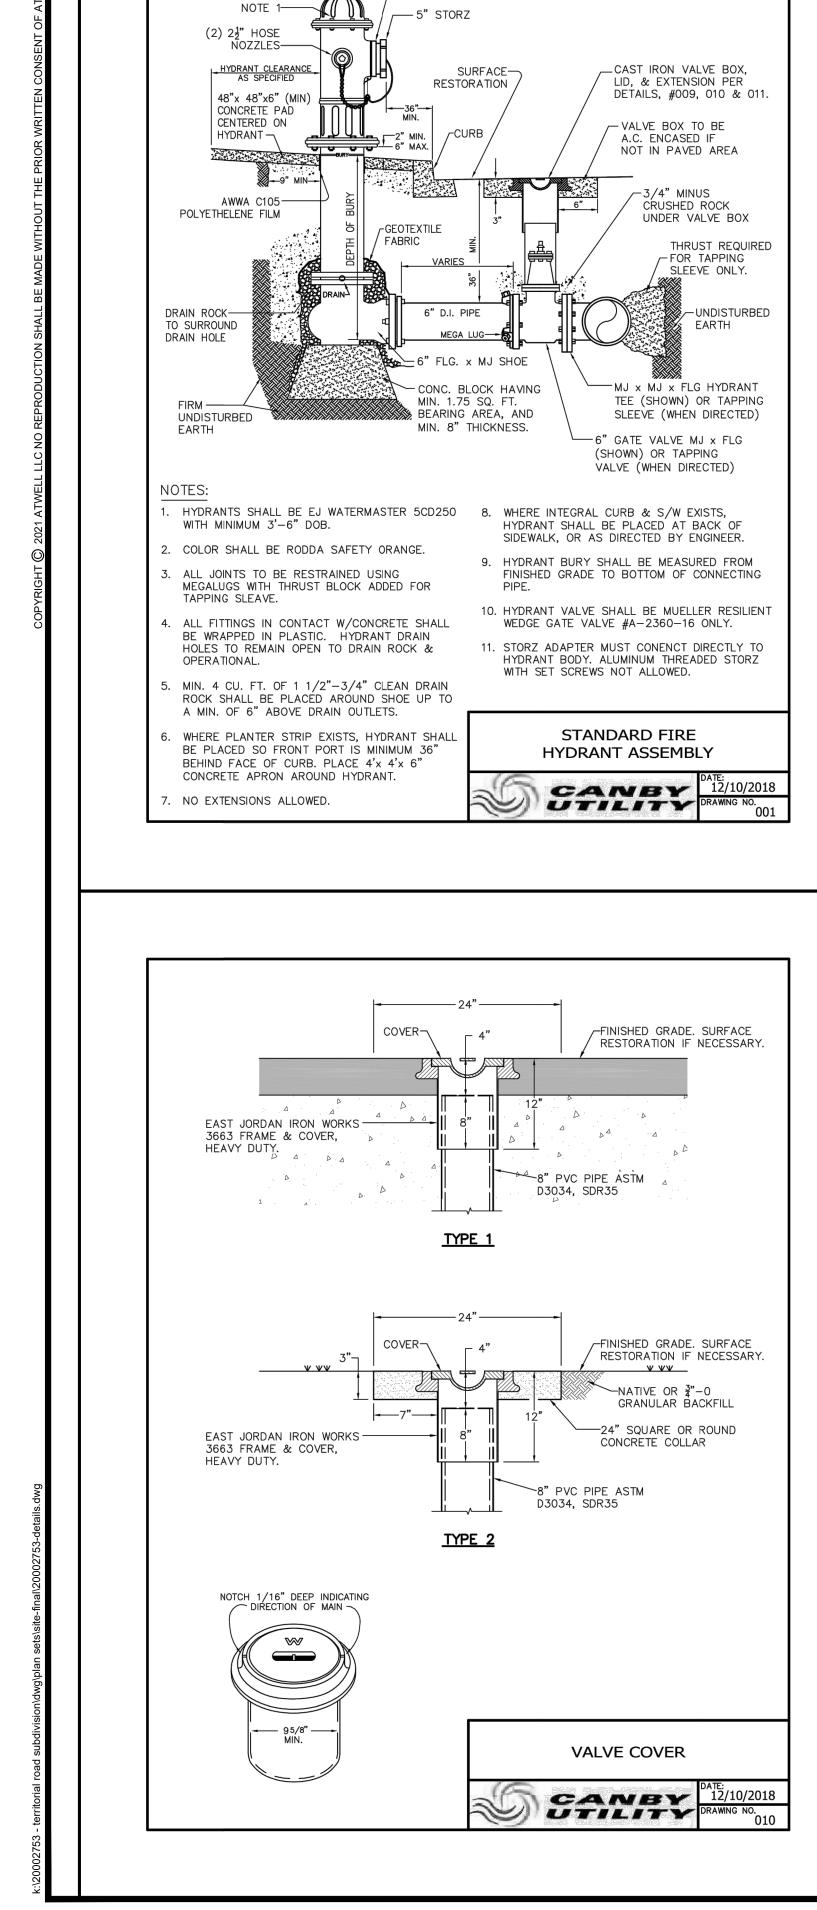


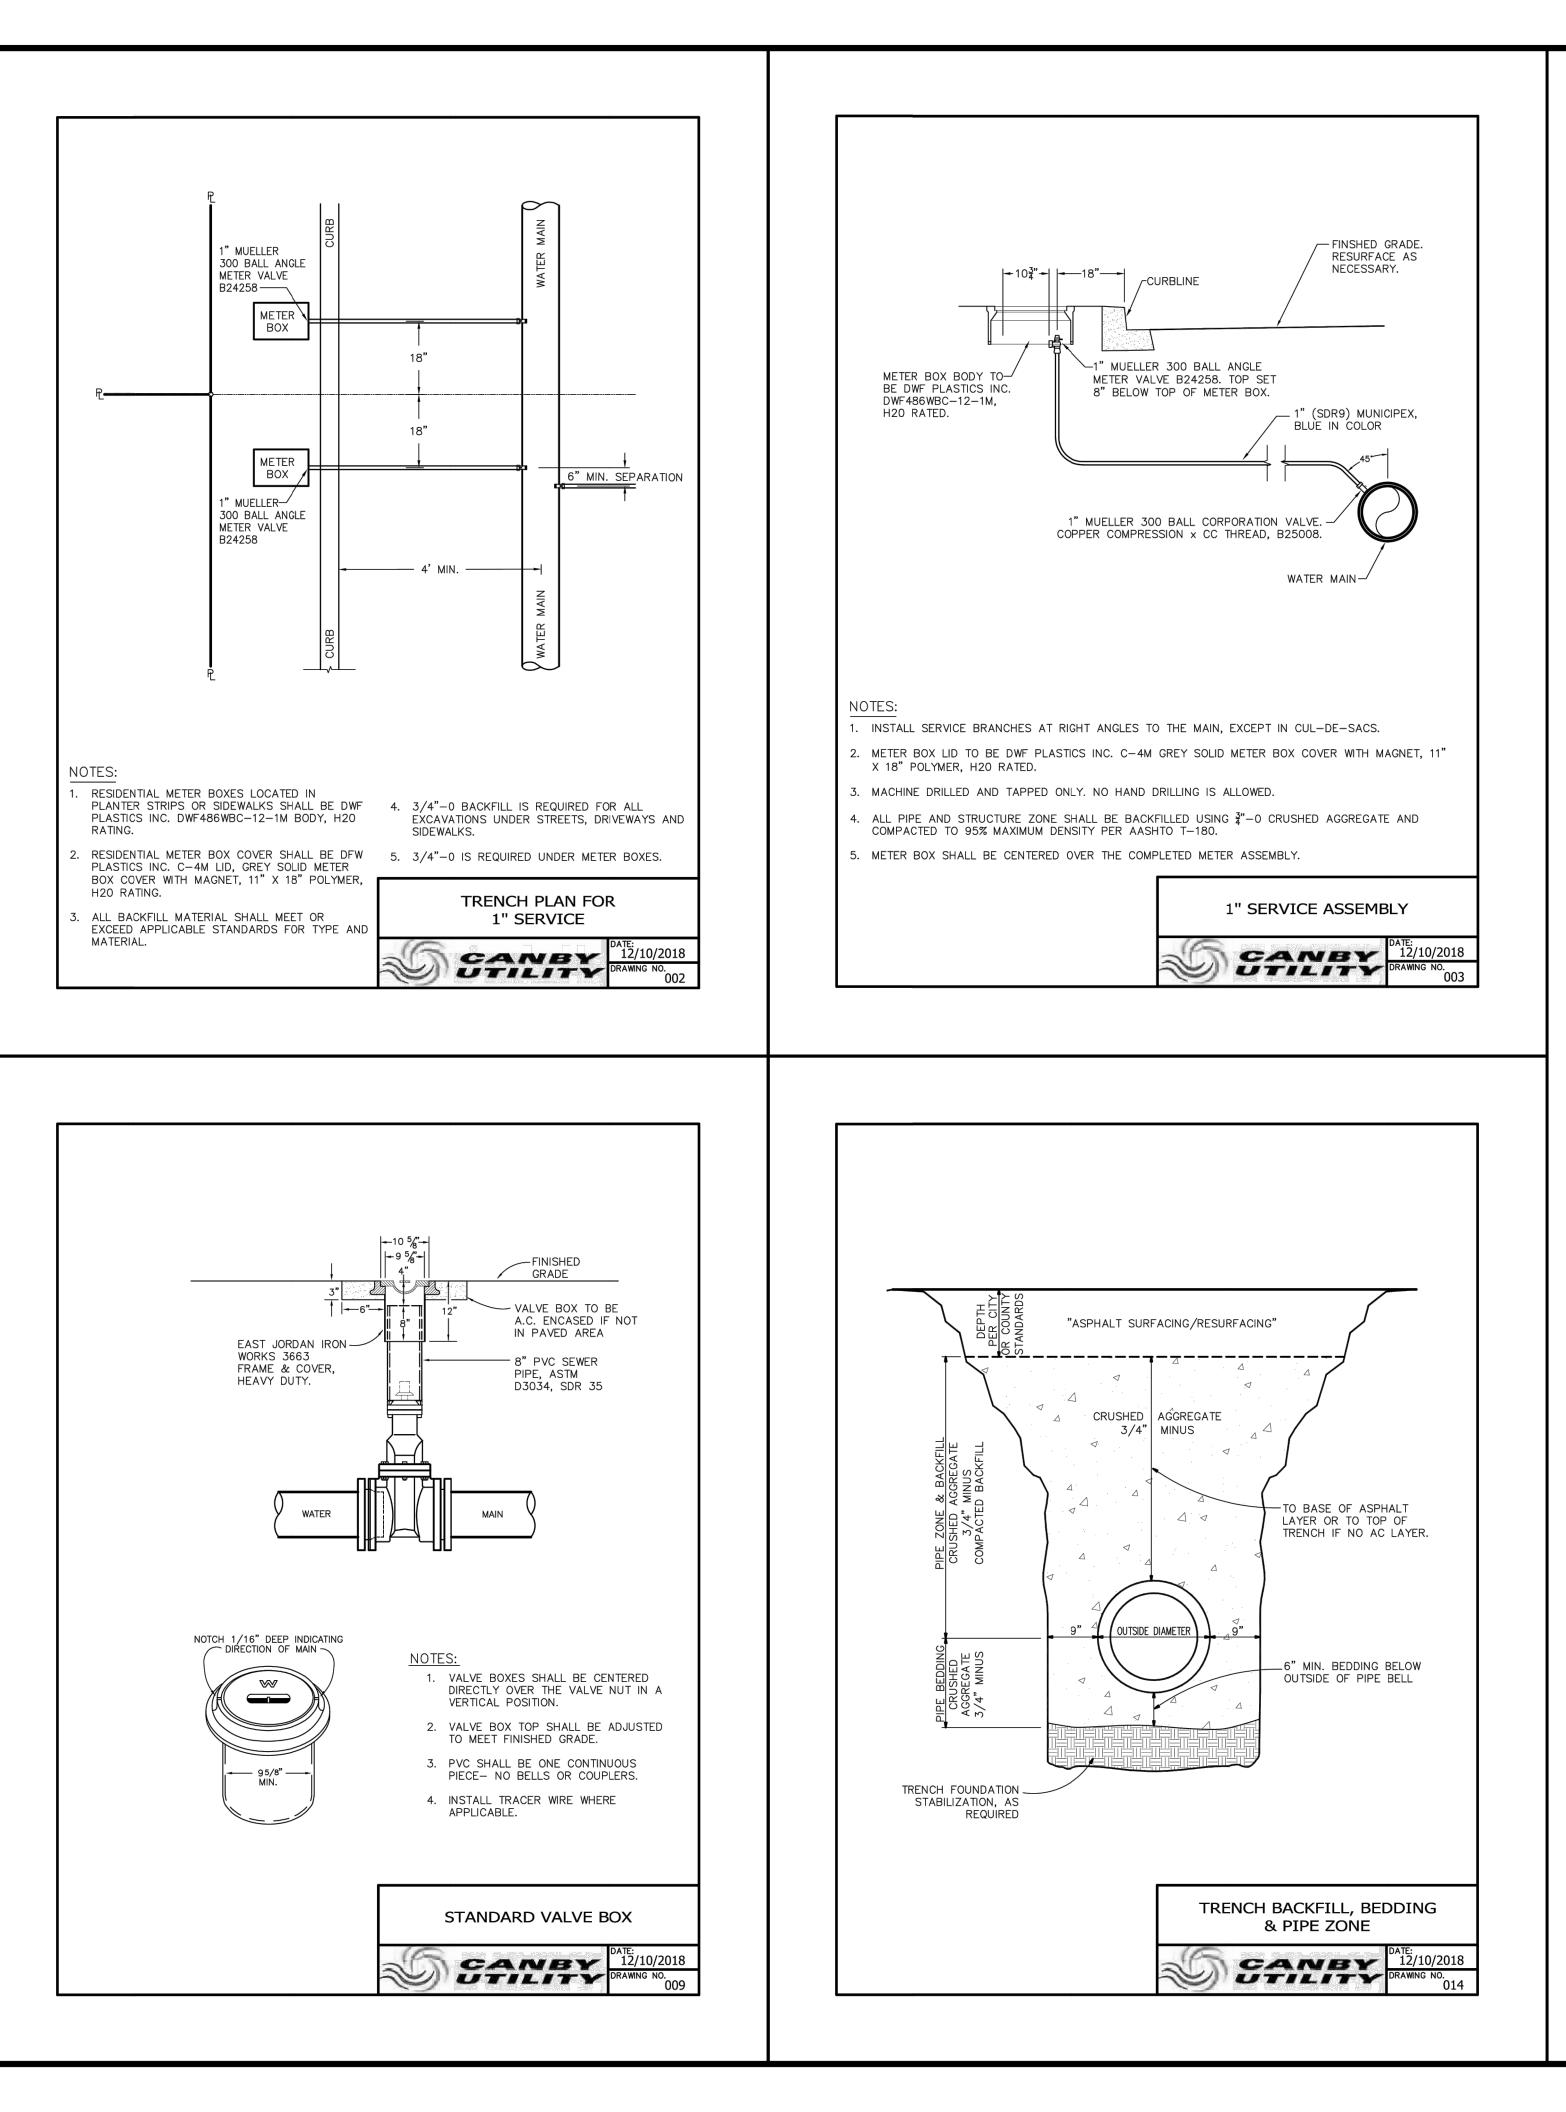


HYDRANT AS


SPECIFIED IN


 $(----(1) 4\frac{1}{2})$ PUMPER NOZZLE

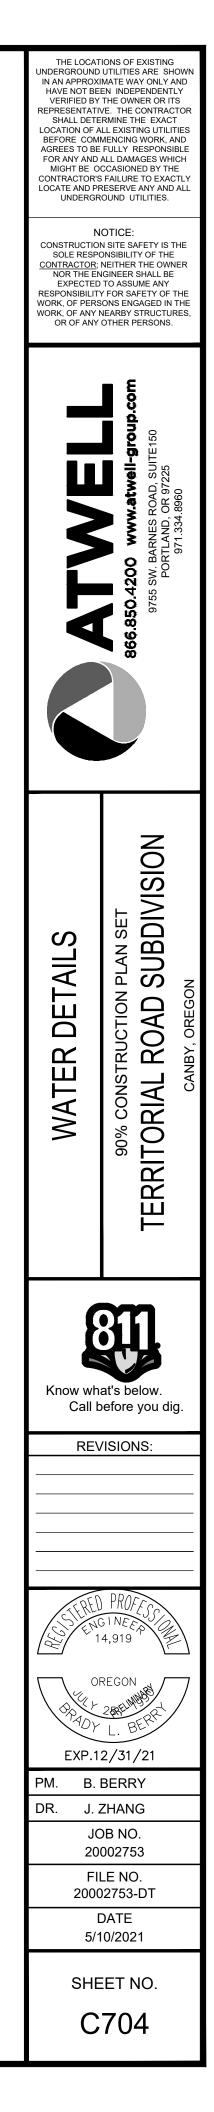


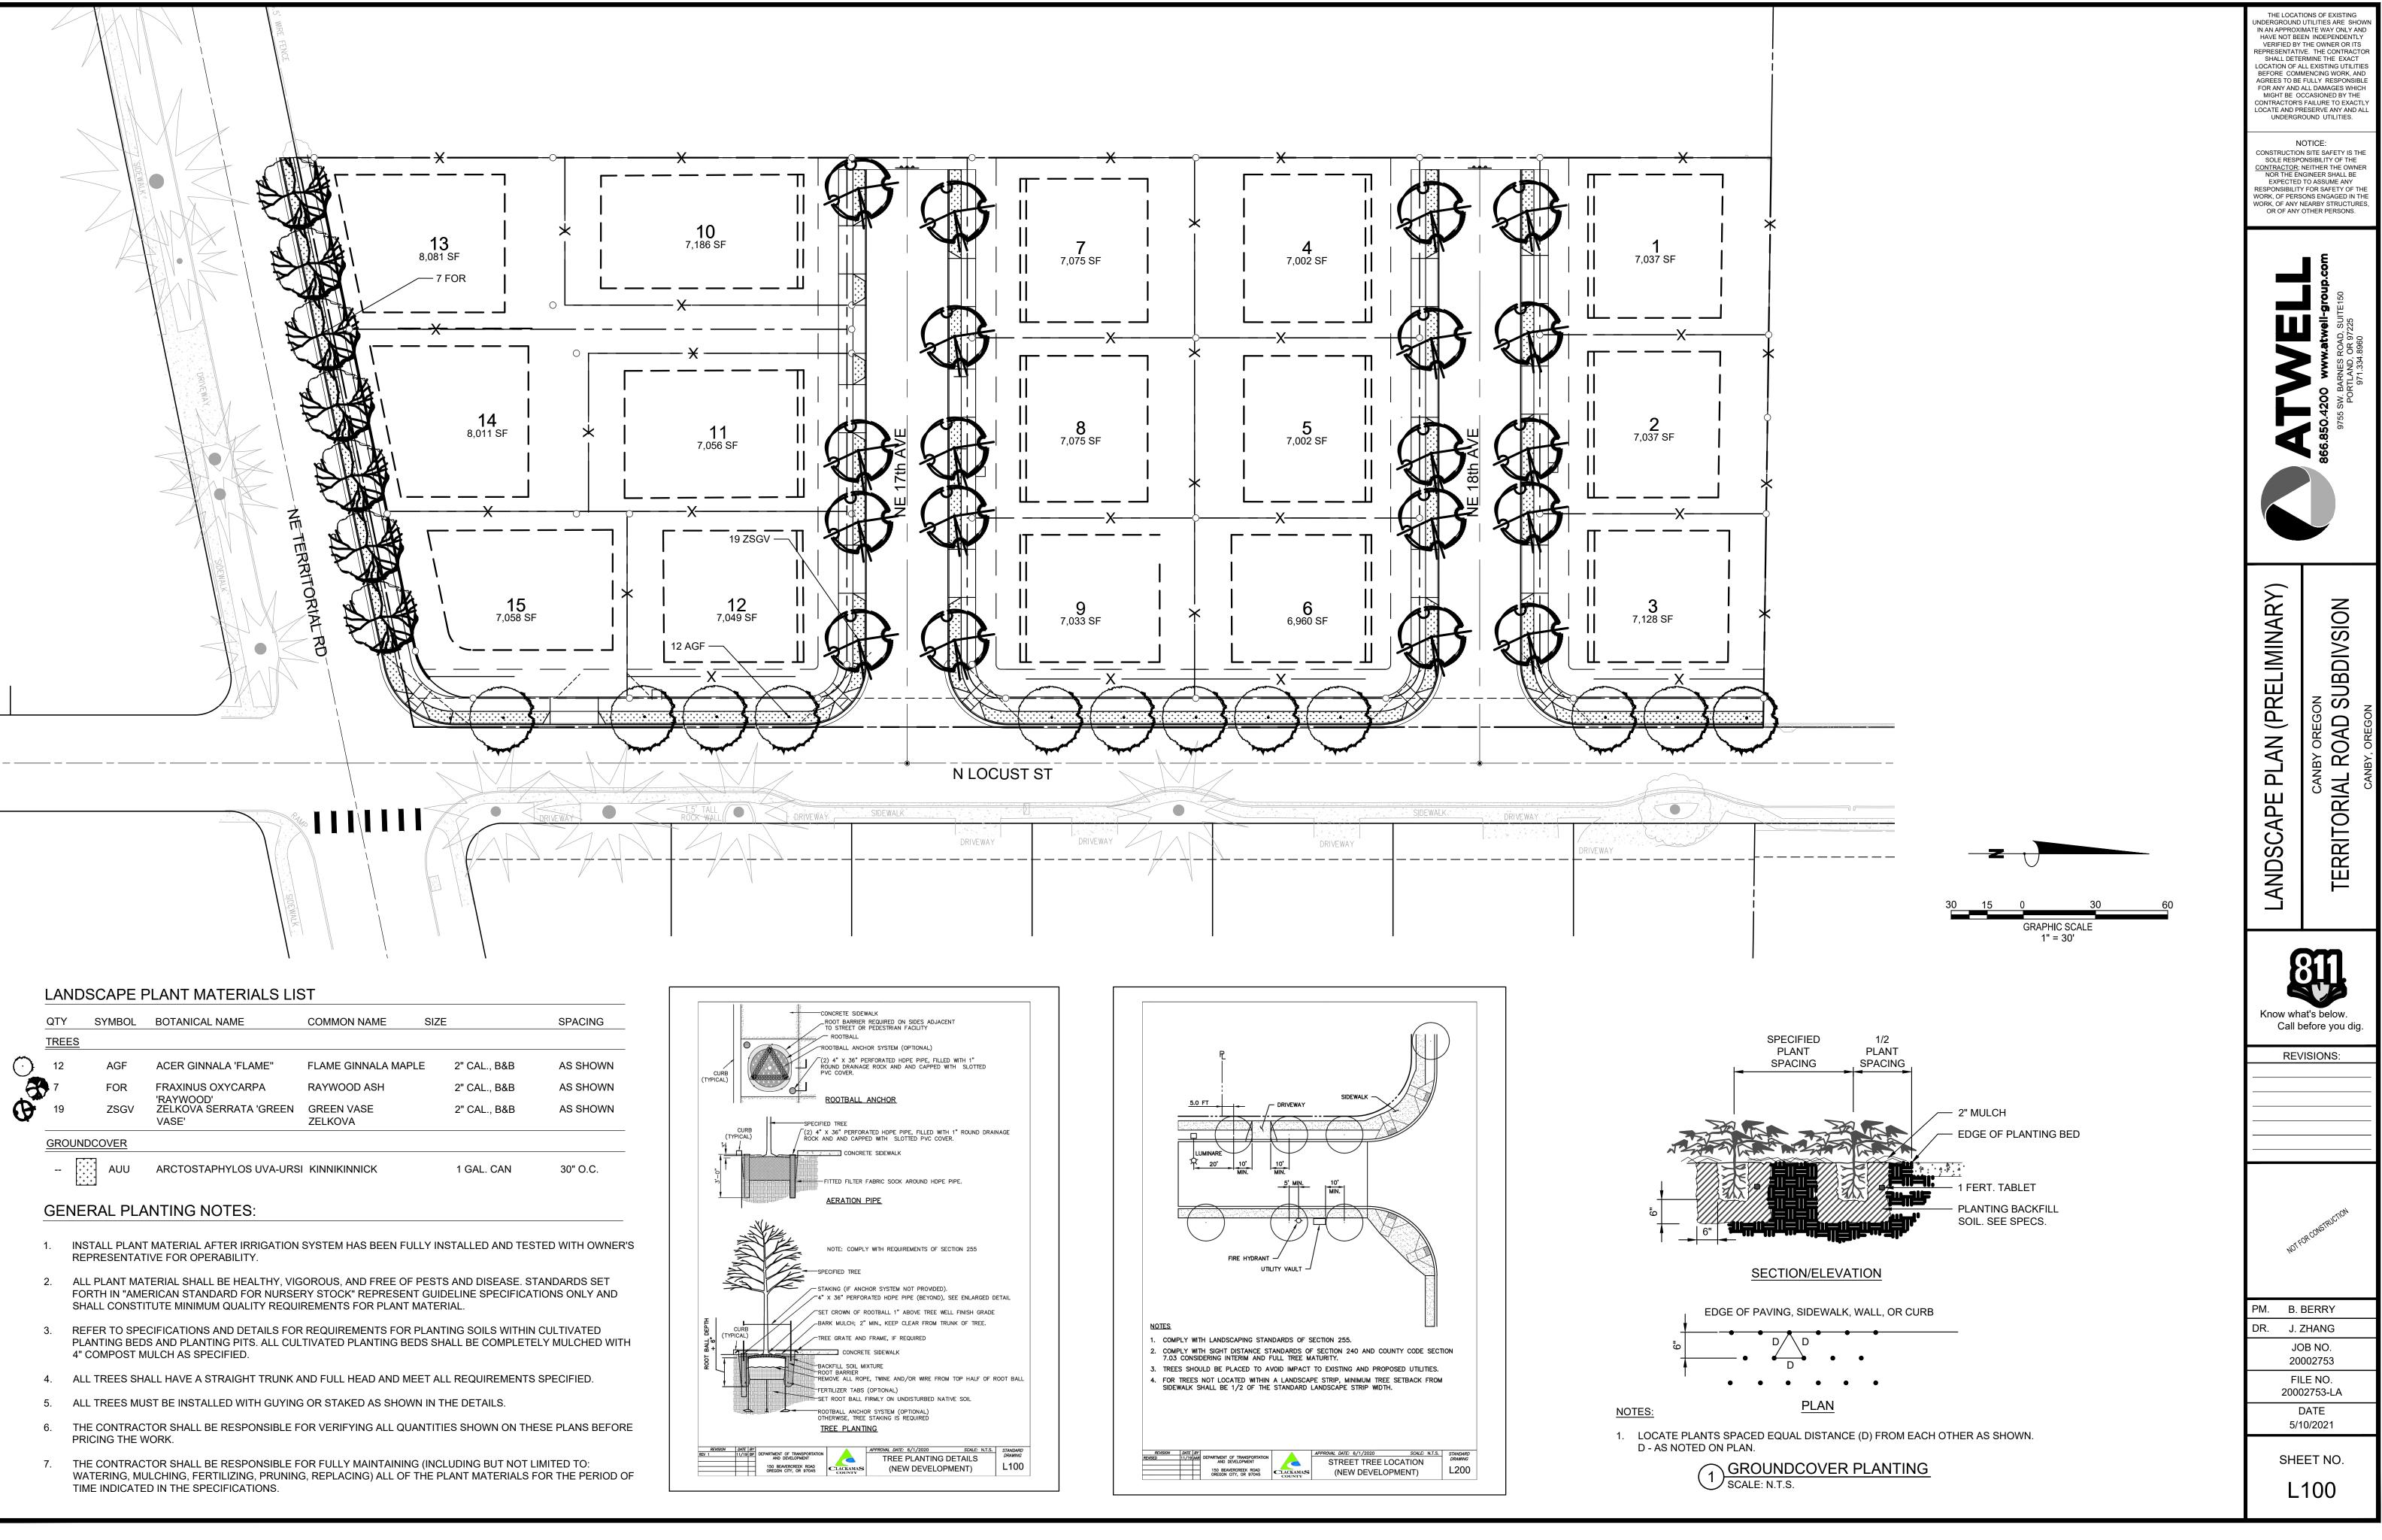


	QTY	SYMBOL	BOTANICAL NAME	COMMON NAME	SIZE	SPACING
	TREES					
Ć	12	AGF	ACER GINNALA 'FLAME"	FLAME GINNALA MAPLE	2" CAL., B&B	AS SHOWN
3	7	FOR	FRAXINUS OXYCARPA	RAYWOOD ASH	2" CAL., B&B	AS SHOWN
Ð	19	ZSGV	'RAYWOOD' ZELKOVA SERRATA 'GREEN VASE'	GREEN VASE ZELKOVA	2" CAL., B&B	AS SHOWN
	GROUNDCOVER					
		AUU	ARCTOSTAPHYLOS UVA-URSI	KINNIKINNICK	1 GAL. CAN	30" O.C.

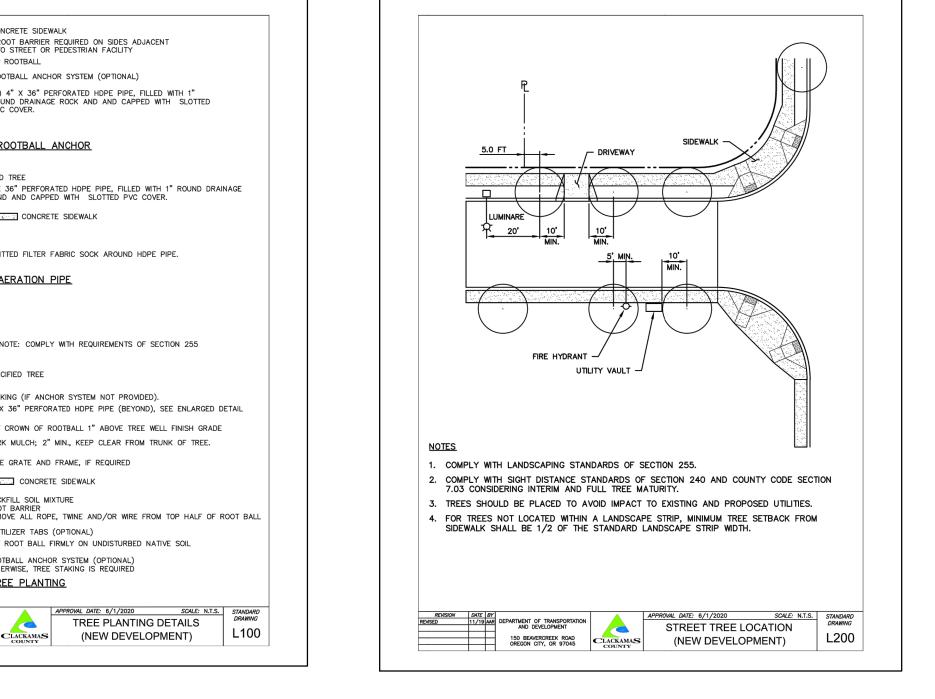

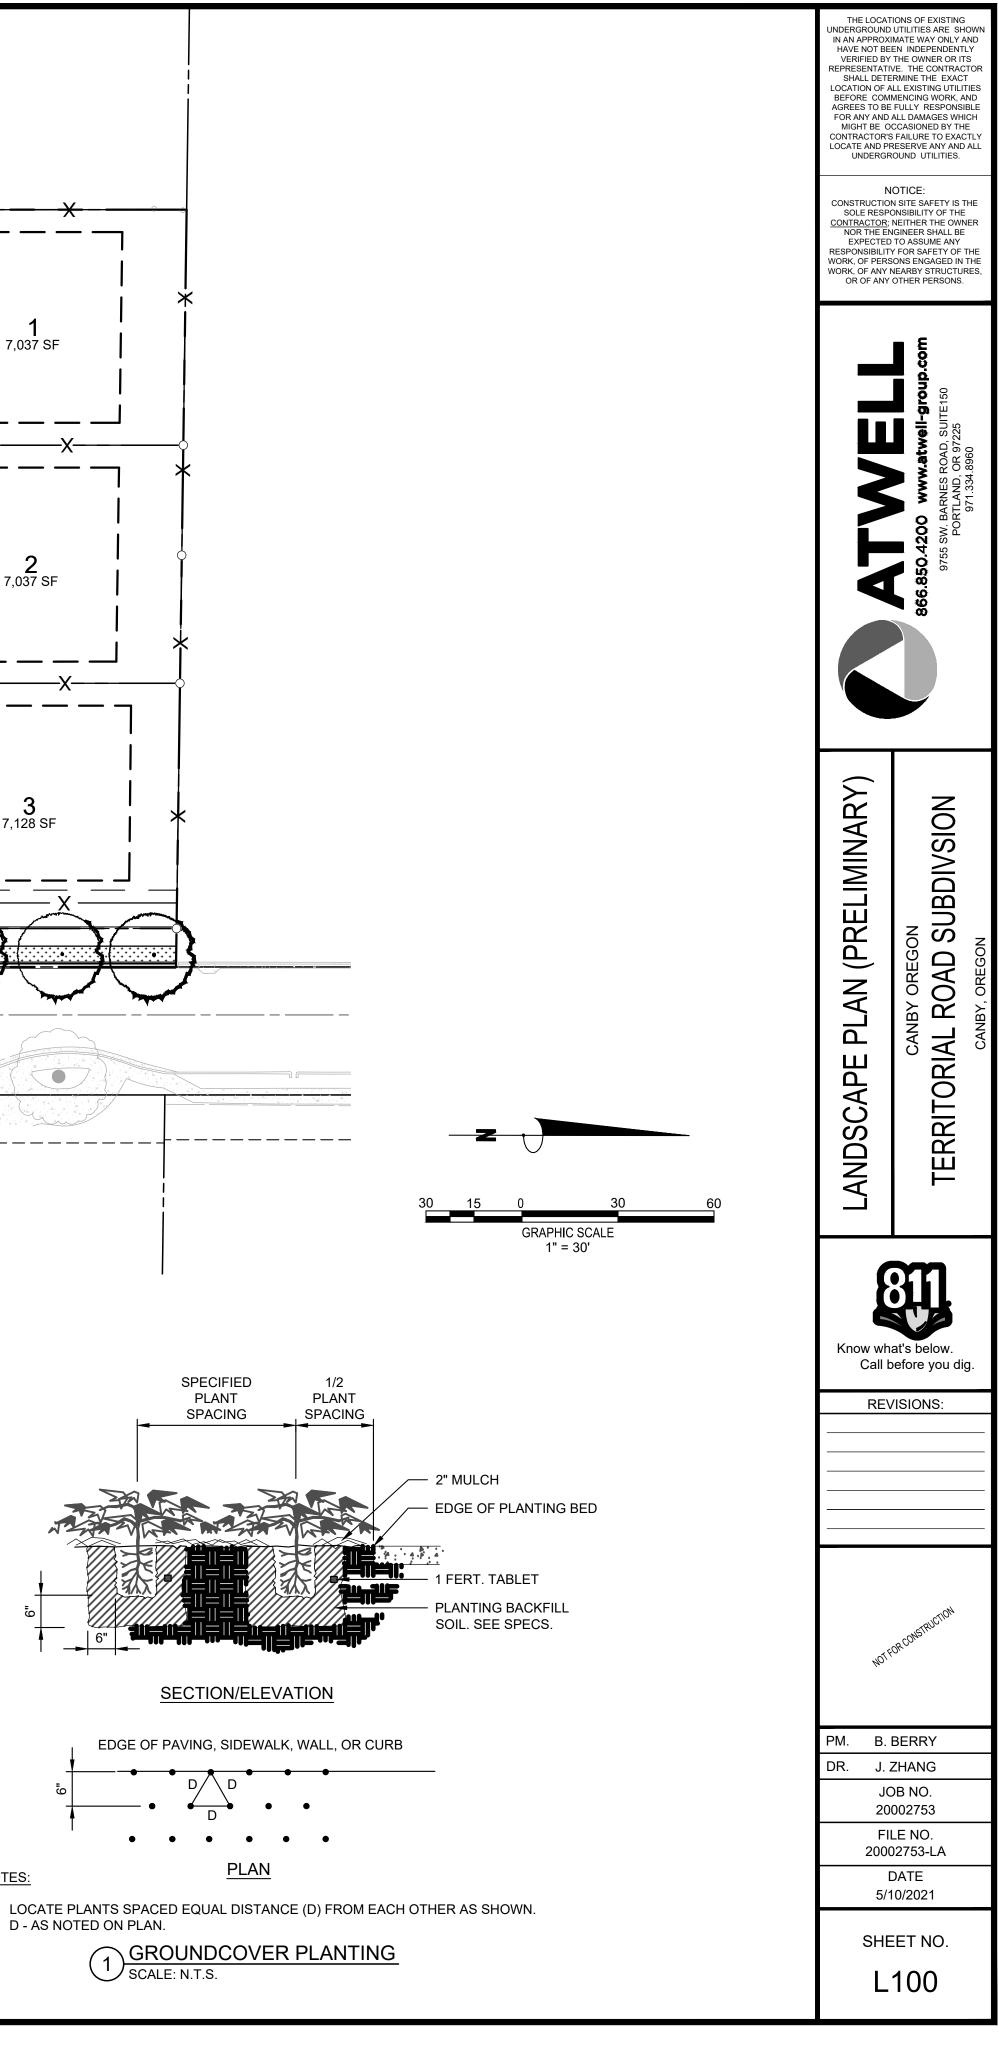

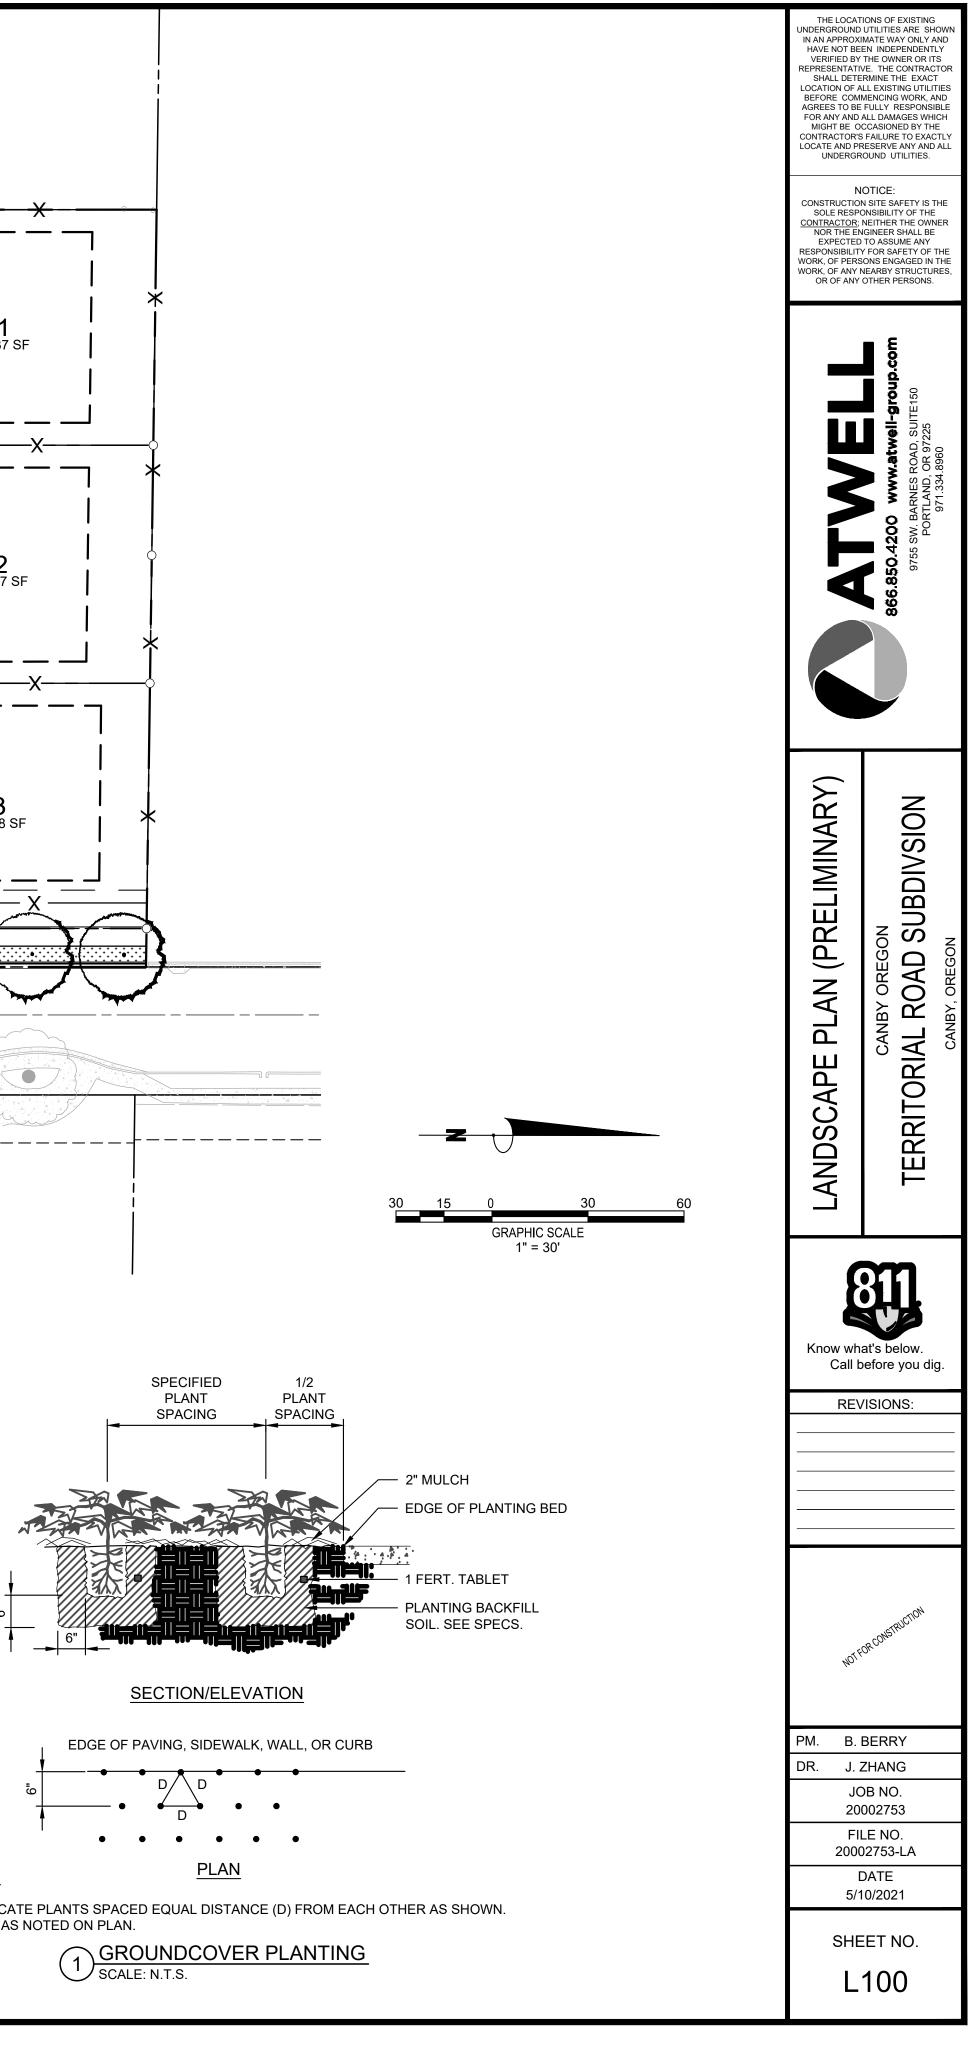

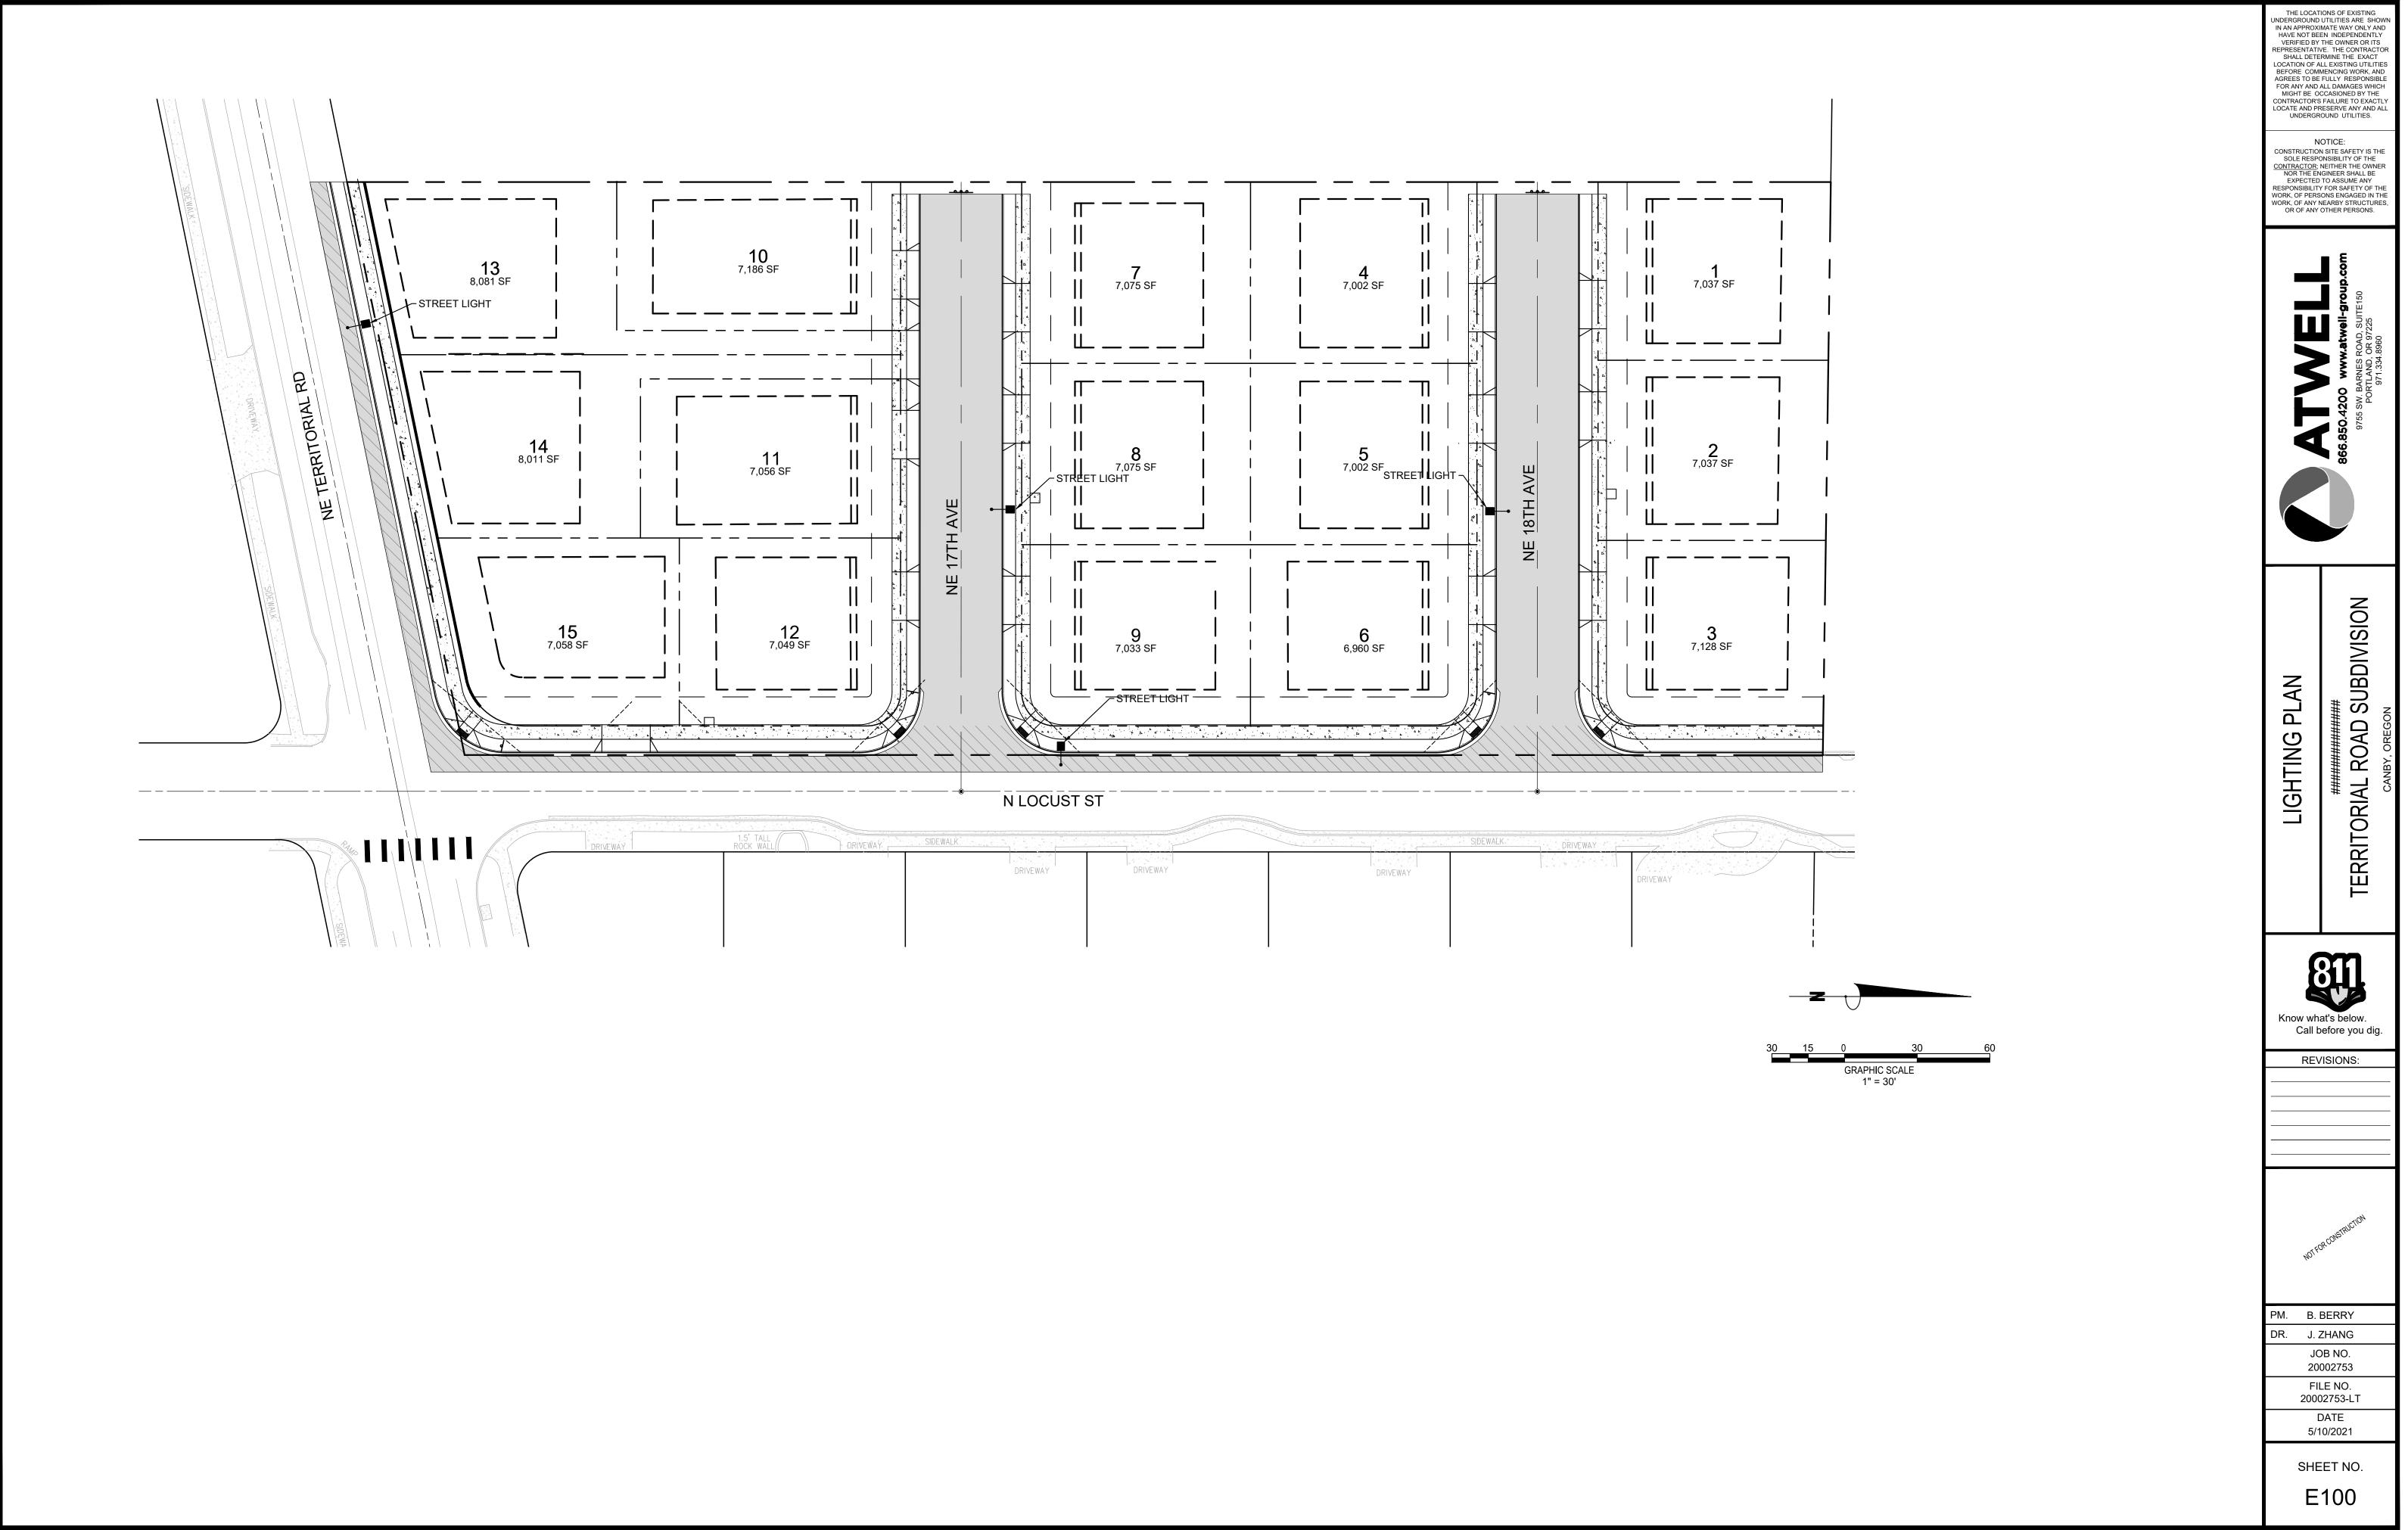

AYSIDEWALK		SIDEWALK				
DRIVEWAY	DRIVE WAY	DRIVEWAY		DRIVEWAY		